

WESTVIEW CHILD DAY CARE CENTER


39 THOMPSON PIKE (ROUTE 21) & 137 WARE ROAD KILLINGLY, CONNECTICUT

PREPARED FOR: WESTVIEW LAND COMPANY

LEGEND

IRON PIN FOUND DRILL HOLE FOUND LIGHT POLE UTILITY POLE WATER GATE CATCH BASIN MANHOLE SANITARY SEWER MANHOLE PERCOLATION TEST HOLE TEST HOLE -100--- EXISTING CONTOURS PROPOSED CONTOURS
INLAND WETLANDS FLAG BUILDING SETBACK LINE WATER LINE STONE WALL ---- SILT FENCE

BEFORE YOU DIG CALL BEFORE YOU DIG AT LEAST TWO FULL BUSINESS DAYS BEFORE DIGGING OR DISTURBING EARTH DIAL 811 OR 1-800-922-4455

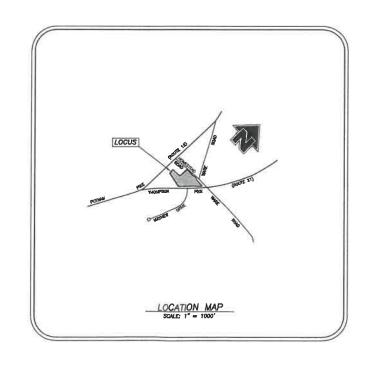

PREPARED BY:



July 2020

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RECEIVED

JAN 1 1 2021

PLANNING & ZONING DEPT. TOWN OF KILLINGLY


FOR REVIEW ONLY **NOT FOR CONSTRUCTION**

FORMAND THESEAULT, JR., P.E. No. 22834 DATE

SHEET 1 OF 8


APPROVED BY THE TOWN OF KILLINGLY INLAND WETLANDS COMMISSION DATE ANY CHANGES TO THESE PLANS WITHIN 200' OF WEILANDS OR WATERCOURSES MUST BE RESUBMITTED TO THE KILLINGLY INLOWD WEILANDS AND WATERCOURS COMMISSION FOR ITS APPROVAL.

APPROVED BY THE TOWN OF KILLINGLY PLANNING AND ZONING COMMISSIO

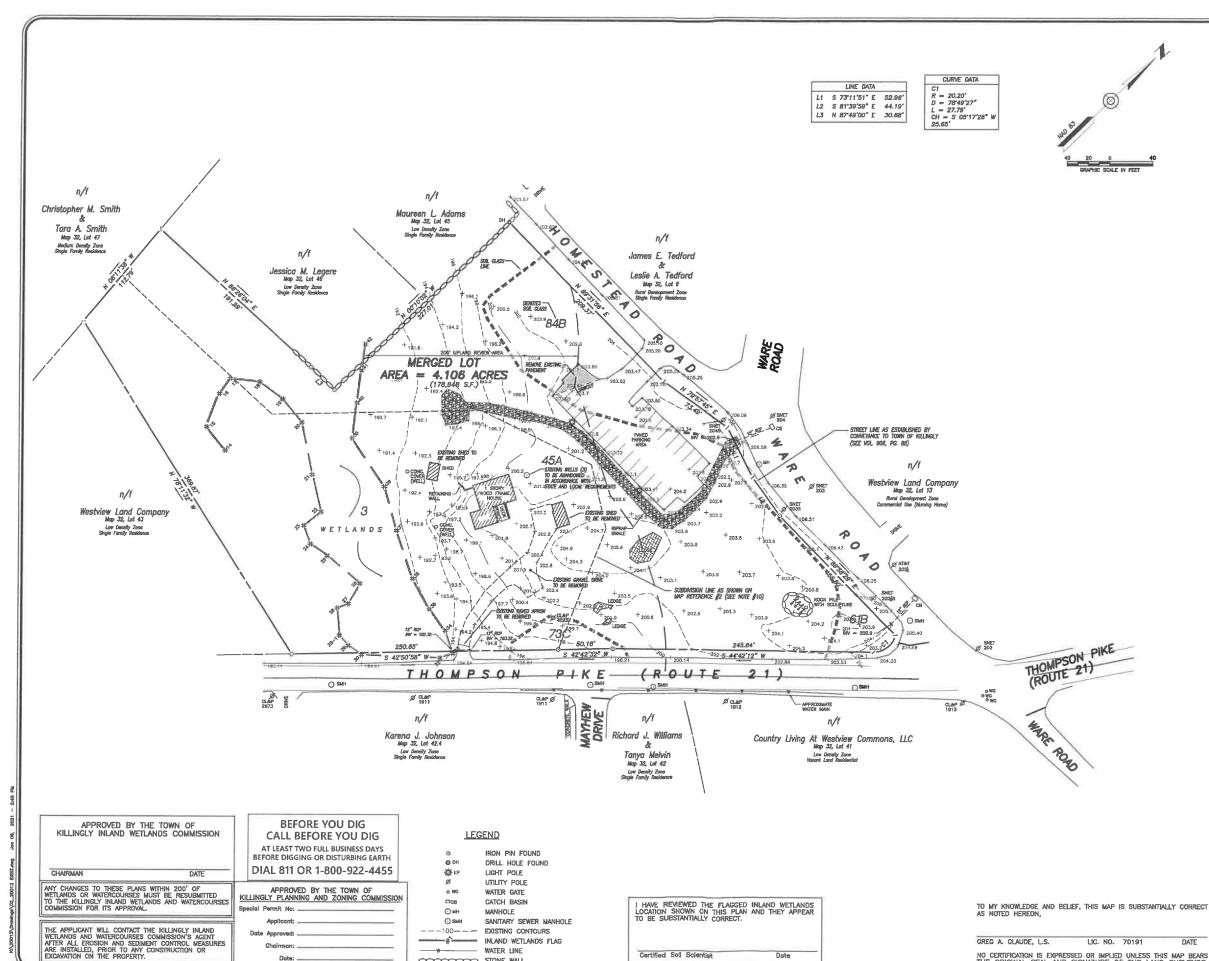

Certified Soll Scientist

COCCOCCO STONE WALL

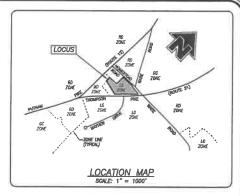

NOTES:

- Topographic features conform to a Class "T-2", "V-2" vertical accuracy.
- Survey Type: Improvement Location Survey.
- Boundary Determination Category: Dependent Resurvey
- 2. Zone = LD.
- 4. Parcel is shown as Lots #44 & 44.1 on Assessors Map #32.
- North orientation, bearings and coordinate values shown are based an North American Datum of 1983 (NAD 83) and are taken from GPS abservations.

- 10. Lots 44 & 44.1 were created by Subdivision in 2007. Both lots were conveyed to Westview Land Company in one deed without an updated legal description. Prior to recording mylars, Lots shall be merged into one undivided lot with an updated legal.

11/02/2020	PER ENGNEERING REVIEW
10/29/2020	SIGNIGE PER CIDOT COMMENTS
10/21/2020	ADDED EXISTING & PROPOSED DRIVEWAY CULVERT
DATE	DESCRIPTION

IMPROVEMENT LOCATION SURVEY EXISTING CONDITIONS / DEMOLITION PLAN

PREPARED FOR


WESTVIEW LAND COMPANY


39 THOMPSON PIKE (ROUTE 21) & 137 WARE ROAD KILLINGLY, CONNECTICUT

NO CERTIFICATION IS EXPRESSED OR IMPLIED UNLESS THIS MAP BEARS THE ORIGINAL SEAL AND SIGNATURE OF THE LAND SURVEYOR.

Killingly Engineering Associates Civil Engineering & Surveying

DATE: 7/16/2020	DRAWN: AMR	
SCALE: 1" = 40"	DESIGN:	
SHEET: 2 OF 8	CHK BY:	
DWG. No: CLIENT FILE	JOB No: 20013	

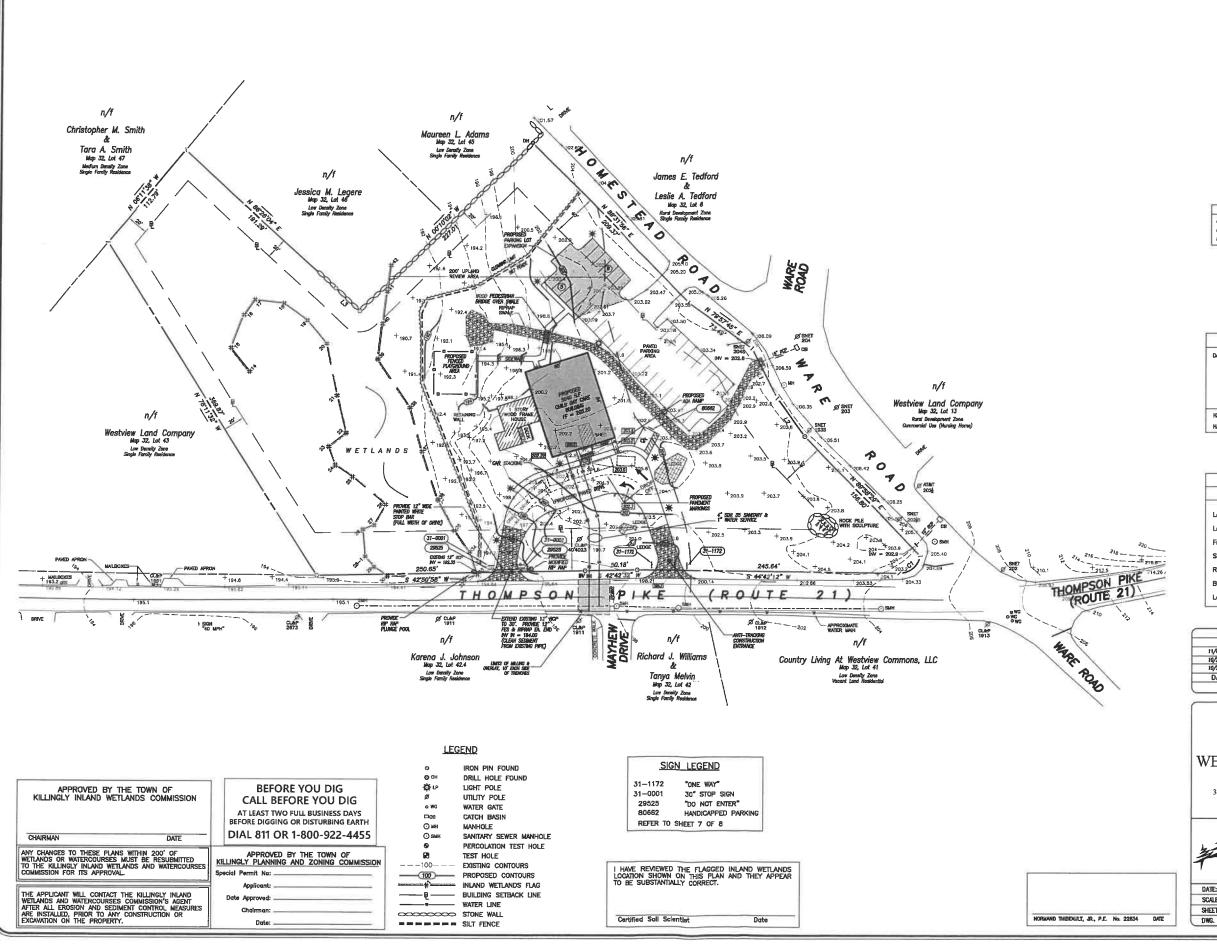

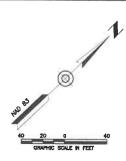

	LINE DATA	
L1	S 73"11"51" E	52.96
L2	S 81'39'59" E	44.19
L3	N 87"49"00" E	30.88

CURVE DATA		
C1 R = 20.20' D = 78*49*27" L = 27.79' CH = \$ 05*17*28" \ 25.65'		

DAY CARE FACILITY

5040 SF GFA / 500 = 11 SPACES

TOTAL REQUIRED = 11 SPACES TOTAL PROVIDED = 11 SPACES

HANDICAPPED SPACES REQUIRED = 1 (VAN ACCESSIBLE)

HANDICAPPED SPACES PROVIDED = 1 (VAN ACCESSIBLE)

TABLE OF Z	ONING REQUIREME	NTS
ZONE	- LOW DENSITY	
Lot Area	REQUIRED 30,000 a.f.	PROVIDED 178,848
Lot frontage	100'	1,111.07
Front Yard Setback	40'	62.6'
Side Yard Setback	20'	266'
Rear Yard Setback	20'	150'
Building Height	35' Max.	26'
Lat Coverage	20% Max.	14.5%

11/02/2020	PER ENGINEERING REVIEW
10/29/2020	SIGNACE PER CITOGT COMMENTS
10/21/2020	ADDED EDISTING & PROPOSED DRIVENAY CULVERY
DATE	DESCRIPTION
	REVISIONS

SITE DEVELOPMENT PLAN

PREPARED FOR


WESTVIEW LAND COMPANY


39 THOMPSON PIKE (ROUTE 21) & 137 WARE ROAD KILLINGLY, CONNECTICUT




Civil Engineering & Surveying

DATE: 7/16/2020	DRAWN: AMR
SCALE: 1" = 40"	DESIGN: NET
SHEET: 3 OF 8	CHK BY:
DWG. No: CLIENT FILE	JOB No: 20013

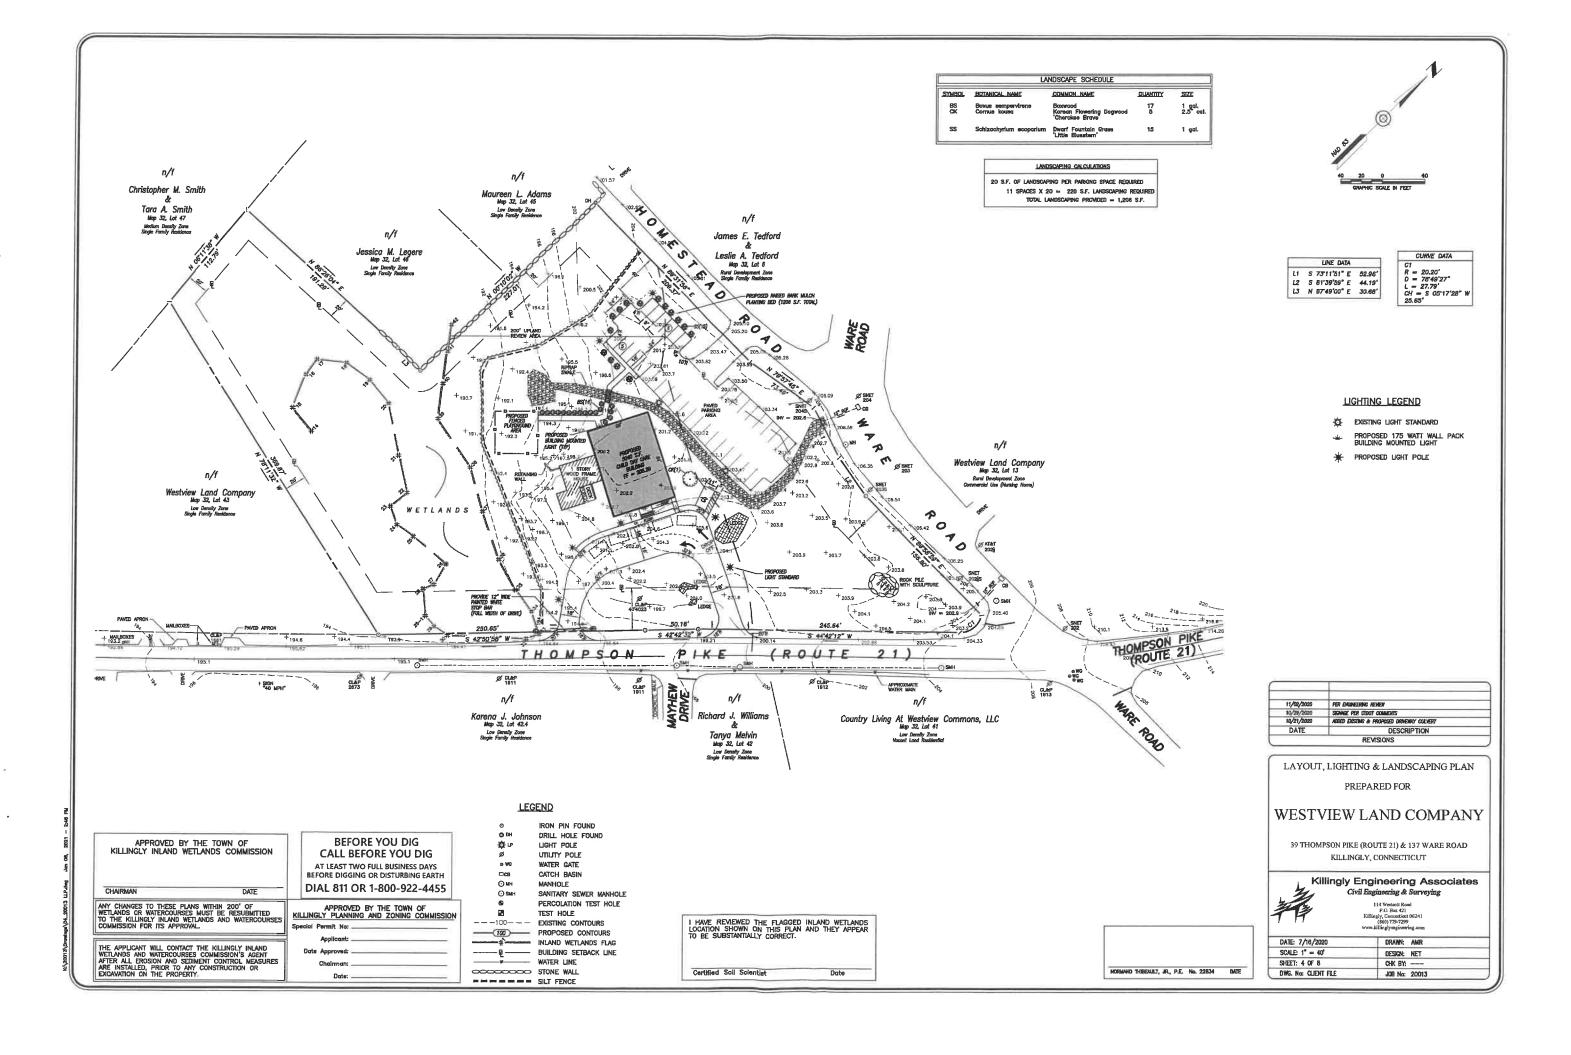


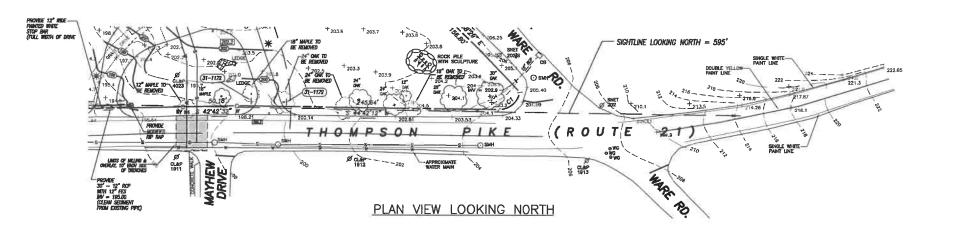

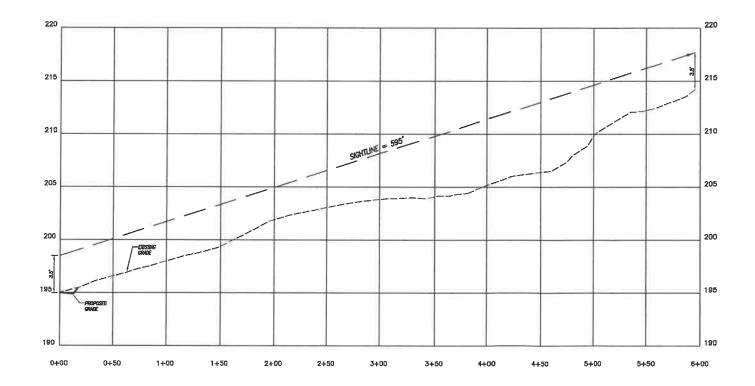

PROFILE LOOKING NORTH

APPROVED BY THE TOWN OF KILLINGLY INLAND WETLANDS COMMISSION	
CHAIRMAN DATE	
ANY CHANGES TO THESE PLANS WITHIN 200' OF WETLANDS OR WATERCOURSES MUST BE RESUBMITTED TO THE KILLINGLY INLAND WATERCOURSES COMMISSION FOR ITS APPROVAL.	APPROVED BY THE TOWN OF KILLINGLY PLANNING AND ZONING COMMISSION Special Perrik No:
THE APPLICANT WILL CONTACT THE KILLINGLY INLAND WETLANDS AND WATERCOURSES COMMISSION'S AGENT AFTER ALL EROSION AND SEDIMENT CONTROL MESSURES ARE INSTALLED, PRIOR TO ANY CONSTRUCTION OR EXCAVATION ON THE PROPERTY.	Applicant: Date Approved: Chairmen: Date:

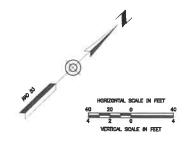

11/02/2020	PER ENGINEERING REVIEW
10/29/2020	SIGNAGE PER CIDOT COMMENTS
10/21/2020	ADDED EXISTING & PROPOSED DRIVENAY CULVERT
DATE	DESCRIPTION
	REVISIONS

SIGHTLINE DEMONSTRATION PLAN LOOKING NORTH

PREPARED FOR

WESTVIEW LAND COMPANY


39 THOMPSON PIKE (ROUTE 21) & 137 WARE ROAD
KILLINGLY, CONNECTICUT





Killingly Engineering Associates
Civil Engineering & Surveying

P.O. Box 421 Killingly, Connecticut 06241 (860) 779-7299 www.killinglyengineering.com

	DATE: 7/16/2020	DATE: 7/16/2020 DRAWN: AMR	
	SCALE: 1" = 40'	DESIGN: NET	
	SHEET: 5 OF 8	CHK BY:	
NORMAND TRIBEAULT, JR., P.E. No. 22834 DATE	DWG. No: CLIENT FILE	JOB No: 20013	

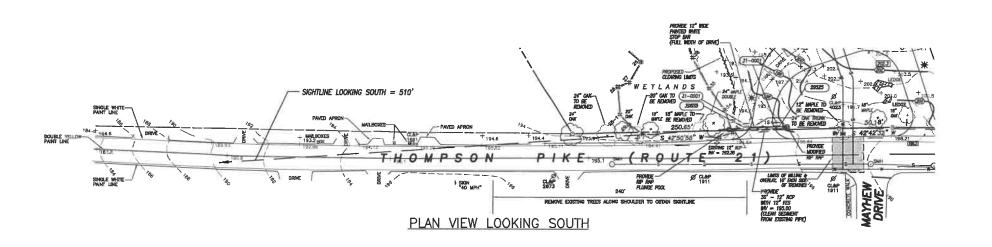

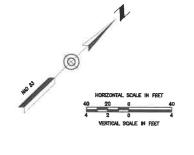

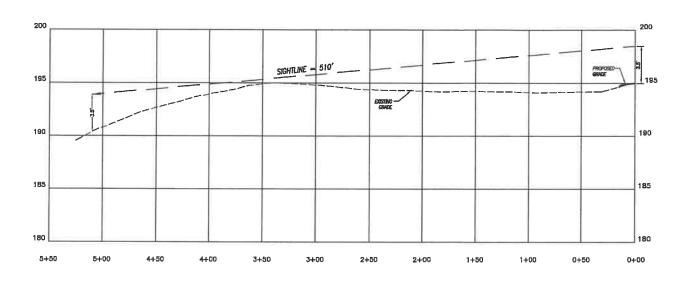

PROFILE LOOKING SOUTH

11/02/2020	PER ENGINEERING REVEN
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10/21/2020	ADDED EXISTING & PROPOSED DRIVEWAY CULVERT
DATE	DESCRIPTION
	REVISIONS

SIGHTLINE DEMONSTRATION PLAN LOOKING SOUTH PREPARED FOR

WESTVIEW LAND COMPANY

39 THOMPSON PIKE (ROUTE 21) & 137 WARE ROAD KILLINGLY, CONNECTICUT



NORMAND THIBEAULT, JR., P.E. No. 22834 DATE

Killingly Engineering Associates
Civil Engineering & Surveying

DATE: 7/16/2020	DRAWN: AMR	
SCALE: 1" = 40'	DESIGN: NET	
SHEET: 6 OF 8	CHK BY:	
DWG. No: CLIENT FILE	J08 No: 20013	

APPROVED BY THE TOWN OF KILLINGLY INLAND WETLANDS COMMISSION

THE APPLICANT WILL CONTACT THE KILLINGLY INLAND WETLANDS AND WATERCOURSES COMMISSION'S AGENT AFTER ALL EROSION AND SEDIMENT CONTROL MEASURES ARE INSTALLED, PRIOR TO ANY CONSTRUCTION OR EXCAVATION ON THE PROPERTY.

APPROVED BY THE TOWN OF KILLINGLY PLANNING AND ZONING COMMISSION Date: _

REFERENCE IS MADE TO:

1. Connecticut Guidelines for Soil Erosion and Sediment Control 2002 (2002 Guidelines).

2. U.S.D.A. N.R.C.S. Web Soil Survey.

The proposed site is comprised mainly of five soil types;
Pidgebury, Lelousiur, and Whitzman (3), Wooderidge (45A), Canton and Chariton (61B),
Chariton-Chatfield (73C) and Poston and Montouk (64B).

3 füdgebury, Leicester, and Whitman soils, extremely stony.

Included with this and in mapping one crose of moderately seel drained Sutton and Woodbridge sells that are alightly higher on the tendedupe. Sutton soils look the Woodbridge sells that are alightly higher on the tendedupe. Sutton soils look they deman authoritant but Woodbridge sells have a look of the mapping of the m

Included with this soil in mapping are areas of well drained Parton and Montanak soils that are higher on the lendecages. Also included are areas of poorly drained Ridgebury soils and very poorly drained Michael soils in the control of the properties and clong drained graving severe soils in depressions and clong drained graving severe. Noderstoky well drained Station soils are included in areas looking a drained severe soil and the soil in the soil in less soil day of the severe substitution. For Particular discoster soils are in depressions and look a dense substitution. Proorly drained discoster soils are in the soil in less cold and locker adherent substitution, soons areas of well drained Stockhidege soils are and moderately affected and related the soil in t

Colored under Control cases, 3 to 5 percent displex, very story

Included with these social in mapping are areas of moderately well drained Sutton
solls in slight depressions on the lundscope, and poorly drained Laliceater soils in
depressions and drainspersych. Also included are areas of moderately deep,
scorneshed excessively droited and well drained Chotdfeld soils where bedroot is 20
to 40 inches bedow the surfoca. Shotioe, scennsivict excessively drained and well
authorized the soll of the surfoca. A few cross in Libratied County Include soils with a sit form surface and
subsect. Minor inclusions makes up about 20 percent of the map unit.
Slope; gently sleping
Landscopes hill on updands
Surface covers: 0 to 3 percent stones
Starfoce covers: 0 to 3 percent stones
Starfoce covers: 0 to 3 percent stones

73C Chariton-Chatfield complex, 3 to 15 percent alopes, very rocky.

Included with these solis in mapping are areas of moderately well drained Sutton solis and poorly drained Laicester solis. Sutton solis are in alight depressions in the madacape, Laicester solis on the depression and drainageway. Asia Included are small creve of shallow, somewhat excessively drained holis solis where bedrook is small or to 20 inches before the surface. A few areas in Highlight County have yellowish red surfaces loyer and subsed. Other areas in Highlight County include sander solis over bedrook. Manor components make up down 25 prevent them. Sopper gently stoping to strangly sloping countries and the subsequence of the map unit. Stope gently stoping to strangly sloping solid like, badrook—combrailed uplands.

Stope gently also prevent down.

848 Poxton and Montouk fire early loams, 3 to 5 percent diops included with these socia in morphing are around moderately well drained Woodshiftings eats in light depressions on the landscope. Also included are pourly drained foliageousy sells in depressions and doing drainageousy. Well drained Conton 100 and 100 are pourly drained foliageousy sells in depressions and doing drainageousy. Well drained Conton 100 are pourly early as a substration. Well drained Soliating early e

- Development of the sits will be performed by the Contractor, who will be responsible for the installation and maintenance of erceion and sediment control measures required throughout
- 2. The sedimentation control precisionism shall remain in place from tests of construction until permanent vegetation has been established. The apprecisionish for the form of Allinghy will be notified when sediment and excellent control structures are initially in place. Any ceditional sell described in the control measures requested by the Town or its agent, shall be hasticated immediately. One the proposed development, essecting and plenting have been completed, the representative shall expand the proposed development, essecting and plenting have been completed, the representative shall expand the proposed development, essecting and plenting have been completed, the representative shall expand the proposed development of the state of the proposed development.
- 3. All stripping is to be confined to the immediate construction area. Topsoil shall be stockpiled so that slopes do not exceed 2 to 1. A hay bale sediment barrier is to surround each stockpile and a temporary regetative conver shall be provided.
- Dust control will be accomplished by spraying with water. The application of calcium chloride is not permitted adjacent to watered resource areas or within 100° of these areas.
- The proposed planting schedule is to be adhered to during the planting of disturbed areas throughout the proposed construction ette.

SILT FENCE INSTALLATION AND MAINTENANCE:

- 1. Dig α 6" deep trunch on the uphill side of the barrier location.
- Position the posts on the downhill side of the barrier and drive the posts 1.5 feet into the ground.

- 4. Inspect and repair barrier after heavy reinfall.

- 7. Replace or repair the fence within 24 hours of observed failure. Failure of the fence has occurred when sediment fails to be retained by the fence because:
 the fence has been overlopped, undervut or 'pipusaed by runoff tectar,
 the fence has been moved out of position (snocked over), or
 the fence has been moved out of position (snocked over), or
 the speaking has decomposed or been demonded.

HAY BALE INSTALLATION AND MAINTENANCE:

- Boles shall be placed as shown on the plane with the ends of the bales tightly
 abutting each other.
- Each bale shall be securely anchored with at least 2 stakes and gaps between bales shall be wedged with straw to prevent water from passing between the
- Inspect bales at least once per week and within 24 hours of the end of a storm with a rainfall amount of 0.5 inches or greater to determine maintenanced.
- Remove sediment behind the bales when it reaches half the height of the bale and deposit in an area which is not regulated by the inland Wetlands
- 5. Replace or repair the barrier within 24 hours of observed failure. Failure of the barrier has occurred when sediment fails to be retained by the barrier because:

 the barrier has been envertopped, undecut or bypassed by runoff setter,

 the barrier has been moved out of position, or

 the hot pides have deteriorated or been damaged.

TEMPORARY VEGETATIVE COVERS

SEED SELECTION

Grass species shall be appropriate for the season and site conditions. Appropriate species are outlined in Figure TS-2 in the 2002 Guidelines. TIMING CONSIDERATIONS

Seed with a temporary seed mixture within 7 days after the suspension of grading work in disturbed areas where the suspension of work is expected to be more than 30 days but less than 1 year.

install needed erosion control measures such as diversions, grade stabilization structures, sediment basins and grassed saterways.

SEEDBED PREPARATION

Losen the soil to a depth of 3—4 inches with a slightly roughened surface. If the area has been recently losened or disturbed, no further roughening is required. Soil preparation can be occomplished by tracking with a bullecare, diseing, harrowing, raking or drogging with a section of chich link fence. Avoid excessive compaction of the surface by equipment travelling back and forth over the surface. If the slope is tracked, the cleat morts shall be perpendicular to the anticipated direction of the flow of surface water.

If soil testing is not practical or feasible on small or variable sites, or where timing is critical, fertilizer may be applied at the rate of 300 pounds per acre or 7.5 pounds per 1,000 square fest of 10–10–10 or equivalent. Additionally, lime may be applied using rates given in Figure 15–1 in the 2002 Cardelines.

SEEDING

MUI CHING

MAINTENANCE

Temporary seedings made during optimum seeding dates shall be mulched according to the recommendations in the 2002 Guidelines. When seeding outside of the recommended dates. Increase the guidelines of mulch to provide 85%-100%

Where seed has moved or where soil erosion has occurred, determine the cause of the fallure. Repair eroded areas and install additional controls if required to prevent recocurrence of erosion.

Continue inspections until the grasses are firmly established. Grasses shall not be considered established until a ground cover la achieved which is moture enough to control soil erosion and to survive severe seather conditions (approximately 80% vegetative cover).

PERMANENT VEGETATIVE COVER:

Refer to Permanent Seeding Measure in the 2002 Guidelines for specific applications and details related to the installation and maintenance of a permanent vegetative cover. In general, the following sequence of operations abell applications.

- Topsoil will be replaced once the excavation and grading has been completed.
 Topsoil will be spread at a minimum compacted depth of 4".
- Once the topsoil has been apread, all stones 2° or larger in any dimension will be removed as well as debris.
- Apply agricultural ground limestone at a rate of 2 tone per acre or 100 lbs. per 1000 a.f. Apply 10-10-10 fertilizer or equivalent at a rate of 300 lbs. per acre or 7.5 lbs. per 1000 a.f. Work lime and fertilizer into the soil to a depth of 4".
- 4. Inspect seedbed before seeding. If traffic has compacted the soil, retill
- 5. Apply the chosen grass seed mix. The recommended seeding dates are: April 1 to June 15 & August 15 October 1.
- Following seeding, firm seedbed with a roller. Mutch immediately following seeding. If a permanent vegetative stand cannot be established by Septe 30, apply a temporary cover on the topsoil such as netting, mat or org mutch.


DEVELOPMENT SCHEDULE/SEQUENCE OF OPERATIONS:

- Flag the limits of disturbance and schedule preconstruction meeting with Town of Killingly watends Agent.
- 2. Contact utility companies for scheduling installation of utilities and connections
- 3. Install the anti-tracking construction entrance.
- 4. Out trees within the defined clearing limits and remove the out wood.
- Install perimeter erosion and sedimentation controls in accordance with the site development plan.
- 6. Chip brush and slash, stockpile chips for use on sits or remove off site.

- 8. install and compact processed gravel for driveway base.
- 10. Strip and stackpille topsoil that is within the footprint of the site. Surround stackpile with sit fence or staked heyboles, and apply temporary seeding in accordance with recommended mixtures. Divert runoff around the perimeter of the stackpile.
- 12. Impact perimeter erosion and sedimentation controls weekly and after ruin events in excess of 0.8°. Repair any damaged controls and provide additional erosion control elevious as necessary to address arrass of consentrated runoff that may develop as a result of the construction additional events and several events of the control of the contro
- 13. Install utilities to edge of right-of-way.
- 14. Prepare sub-base for driveway and remainder of the site for final grading.
- Excavate for building footings, stockpile soil and pour feetings & slab. Begin building construction.
- Place topsoil where required and install any proposed landscaping upon completion of each building.
- 17.Install first course of povement to each building as they are completed.
- 19. Install find course of pavement upon the completion of the final structure
- 20. Fine grade, rake, seed and mulch to within 2° of the pavement.
- Remove and dispose of all sit fence and hay bales after the site has been stabilized to the satisfaction of the Town of Killingly.

RESPONSIBLE PARTY FOR E&S MAINTENANCE:

David Panteleakoa Westview Healthcare Center 150 Ware Road Killingly, CT 06241 (860) 377-6030

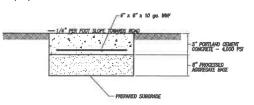


SECTION THRU CONCRETE SIDEWALK NOT TO SOME

BOLTS - HEX HEADJINTEGRAL FLANGE CONFORMING TO ASTM A354. -18 UNC X 1.75", GRADE BC FOR 3.00 LBS./FT. POSTS -18 UNC X 2.0", GRADE BD FOR 4.00 LB./FT. POSTS.

NUTS -18 UNC HEX HEAD, INTEGRAL FLANGE CONFORMING TO ASTM A563, GRADE DH.

LOCKWASHERS - HEAVY DUTY EXTERNAL TYPE.

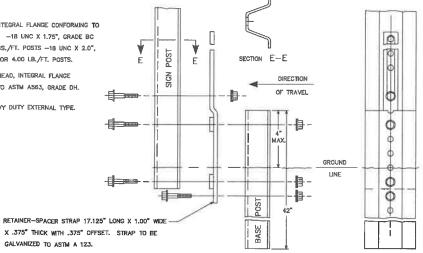

BREAKAWAY TYPE I INSTALLATION - FOR 3 & 4 LB. POSTS






ONE WAY SIGN DETAIL



DO NOT ENTER SIGN

NOT TO SCALE

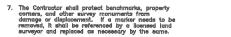

Jeth Se

BITUMINOUS CONCRETE PAVEMENT

NOT TO SOME

The Contractor shall be responsible for preparing and compacting base for proposed powersert.
 Owner shall provide general fill to establish subgrade — contractor shall spread and compact. Contractor shall provide, spread and compact required processed aggregate.

1. The locations of existing utilities are based upon visible field observations, record mapping and missible field observations, record mapping and missible field observations, record mapping and missible field observations, and the property owners. They are is shown for informational purposes only. Contractor shall coordinate exploratory test hole securation with the Engineer if necessary to verify and/or determine actual locations of some utilities a structures. It is the responsibility of the contractor to verify the location and elevation of all utilities. Contact "OALI BEFORE YOU DIG" at 1—800—922—4455, and obtain all applicable parmits, prior to any excavation around utilities.

All existing site features not scheduled to re-shall be removed and dispassed of in a prope manner, by the contractor.

All Moterials and methods of construction shall conform to "State of Connecticut, Department of Transportation, Standard Specifications for Roads, Bridges and Incidental Construction, Form 817", and supplements thereto.

The Contractor shall obtain copies of all regulatory agency permits from the Owner prior to any site disturbance.

5. Unless otherwise noted on the plans, the contractor shall use the geometry provided on the construction plans. Benchmark information shall be provided to the contractor by the Owner or the Cowner's surveyor. Any discrepancies between field entire the plant of the contractor of the plant of the pla

CONSTRUCTION NOTES/GENERAL PROVISIONS

The entire project site shall be thoroughly cleaned at the completion of the work. Clean all installed paved areas, occumulated sit and sediment, plus all adjacent areas affected by the construction activities as directed by the Owner or the jurisdictional Agence.

I 1/2" CLASS II BELANDOLS CONCRETE I 1/2" CLASS I BELANDOLS CONCRETE





SILT FENCE

(z)-z'hz'ha' sunes

HAYBALE BARRIER

0 0 0 0 0 0

ANGLE TO UP SLOPE FOR STABLETY AND SELF CLEANING

80662 30" VIOLATORS WILL BE FINED MIN. \$150 8 STOP HANDICAPPED **PARKING** STOP SIGN REQUIRED

CONSTRUCTION ENTRANCE

11/02/2020 PER ENGINEERING REVIEW SIGNAGE PER CIDOT COMMENTS ADDED EXISTING & PROPOSED DRIVENAY CULVERT DATE DESCRIPTION REVISIONS

DETAIL SHEET No. 1 PREPARED FOR

WESTVIEW LAND COMPANY

39 THOMPSON PIKE (ROUTE 21) & 137 WARE ROAD KILLINGLY, CONNECTICUT



Civil Engineering & Surveying 114 Westcott Road P.O. Box 421 Killingty, Connecticut 06241 (860) 779-7299 www.killingtyengineering.com

DRAWN: AMR DESIGN: NET CHK BY: ----

JOB No: 20013

TO THE KILLINGLY INLAND WETLANDS AND WATERCOURSES COMMISSION FOR ITS APPROVAL

THE APPLICANT WILL CONTACT THE KILLINGLY INLAND WETLANDS AND WATERCOURSES COMMISSION'S AGENT AFTER ALL EROSION AND SEDIMENT CONTROL MEASURES ARE INSTALLED, PRIOR TO ANY CONSTRUCTION OR EXCAVATION ON THE PROPERTY.

APPROVED BY THE TOWN OF

KILLINGLY INLAND WETLANDS COMMISSION

BEFORE YOU DIG CALL BEFORE YOU DIG AT LEAST TWO FULL BUSINESS DAYS BEFORE DIGGING OR DISTURBING EARTH


APPROVED BY THE TOWN OF KILLINGLY PLANNING AND ZONING COMMISSION Special Permit No: .

DIAL 811 OR 1-800-922-4455

Date: _

Date Approved:

CHAIRMAN

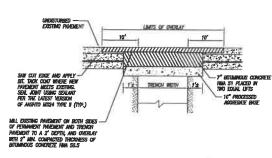

MILLING AND OVERLAY (Perpendicular) STATE ROAD - ROUTE

NOT TO SCALE

CENERAL MOTIES

1. THESE DEFINES ARE REPORDED FOR USE ON ROLLS WITH AND WITHOUT CONCRETE PROBABILITY.

2. FOR TOWARD IN CONCRETE PROBABILITY STRUCTURES, ANY PORTION OF THE REMAINS CONCRETE SUB-C-S' SHALL BE REMAINED IN THIS DUTBERT OR AS DIRECTED BY THE DEMAINED.

3. WIGHT OF PROMAINED OR TEMPORARY PROBABILITY SHALL BE 2' WIDER THAN THE TRENCH DUDARDON OR AS FIELD CONDITIONS WARRANT AS DIRECTED BY THE DEMAINED.

4. T* (10' OF 19 MACK FOR THAN PROBABILIMATIONS SHALL BE AT THE DISCRETION OF THE DEMAINED.

5. ALL DISTRIBED PROBABILITY MARROWS SHALL BE RESTORED AS ORDERED BY THE DEMAINED.

PERMANENT PAVEMENT (Perpendicular)

STATE ROAD


1'± THENCH MOTH 1'±

CEMENAL MITTES.

1. THESE CERMAS ARE INTENDED FOR USE ON ROADS WITH AND WITHOUT CONCRETE PARKENT STRUCTURES.

2. FIRE TREATED IN CONCRETE PARKENT STRUCTURES, ANY PORTION OF THE REMANDING CONCRETE SLAR < 3" SHALL BE REMANDED IN THE DIRECTOR. AND INTENDED TO THE DIRECTOR SHALL BE 2" MISSER THAN THE TRENCH EXCONTION OR AS FIELD CONDITIONS WARRANT AS DIRECTOR DIF THE DIRECTOR. WHITHIS WILL BE 3" WISSER THAN THE TRENCH EXCONTION OR AS FIELD CONDITIONS WHEN AS DIRECTOR DIF THE PARKET PROBLEM THAN THE TRENCH EXCONTION OF THE ENGINEER ± 10" M ANY DIRECTORN.

5. ALL DISTURBED PROBLEMIT MAPPOINTS SHALL BE RESTORED AS DIRECTED BY THE DIRECTORN.

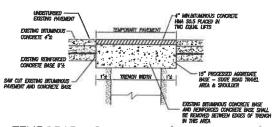

TEMPORARY PAVEMENT (Perpendicular) STATE ROAD

SCHEMIL INTERS:

1. THESE CEPILS ARE INTERNED FOR USE ON ROADS WITH AND WITHOUT CONCRETE PARABEIT STRUCTURES.


2. THE TREAM'S AND CONCRETE PARABEIT STRUCTURES, ANY PORTION OF THE ROADWARD CONCRETE SLAR < 5' SHALL BE REMOVED IN ITS DIFFICIENT ON AS DIRECTED BY HE INDIRECT.


3. WITH OF PROMISENT OF THE PARABEIT.

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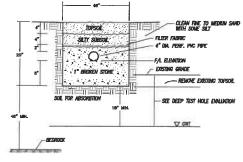
4. TY ("OF OUT BACK) FOR THAN, PARABEIT WALLIAMS, WILL BE AT THE DESCRIPTION OF THE BROWERF ± 10' IN ANY DIRECTION.

3. ALL DISTURBED PARABEIT WARDNESS SHALL BE RESTORED AS CIRCLED BY THE BROWERF.




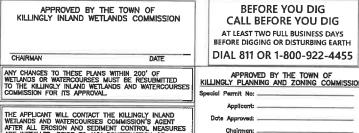

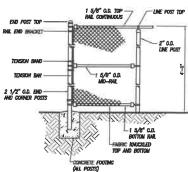CHAIN LINK FENCE DETAIL




TYPICAL LEACHING TRENCH SECTION

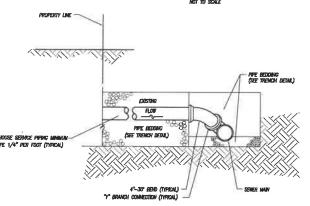


SEWER CONNECTION DETAIL NOT TO SCALE




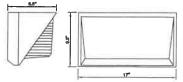


BUILDING MOUNTED LIGHT

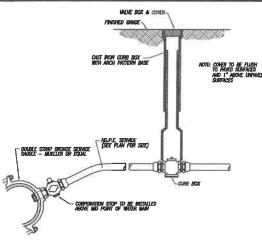

TYPICAL WATER SERVICE CONNECTION NOT TO SCALE

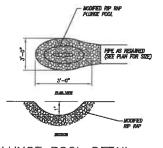


PLUNGE POOL DETAIL

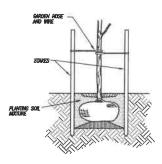


REFERENCE: GUIDELINES FOR SOIL EROSION AND SEDMENT CONTROL

PLANTING CROSS SECTION FOR TREES UNDER 20'

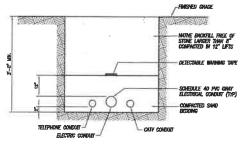

NOTE: CONTRACTOR SHALL PROMDE SET/CLAY DAWS AT 100' INTERNALS ALONG PROPOSED UTILITY TRENCH TO AVOID TRANSPORTING INTERCEPTED WATER.

UNDERGROUND UTILITY TRENCH

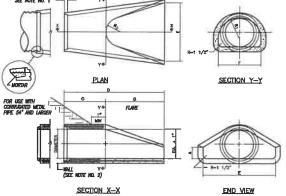

1. JOINTS SHALL BE TONGUE AND GROOME OR BELL AND SPIGOT AS REQUIRED TO CONFORM TO PIPE INSTALLED

DIMENSIONS FOR REINFORCED CONCRETE CULVERT END					FLARED REINFORCEMENT					
DIA.	A	В	C	D	E	F	R ₁	Ra	THE	
12"	4"	2'-0"	4'-0 3/8"	8'-0 3/8"	2'-0"	1-7 15/15	10 1/4"	6"	0.048	0.048
15"	6"	2-3	3'-10"	6'1°	2'-6"	Z-0 6/16"	1'-0 1/2"	11"	0.054	0.054
18*	8,	2-3"	3'-10"	6'-1"	3'-0"	2-5	1'-3 1/2"	1"-0"	0.060	0.080
21°	9,	Z'-11°	3'-2"	6'-1"	3'-6"	2-7 1/2	1"-4"	1'-1"	0.056	0.088
24"	0 1/2"	3-7 1/2"	2'-6"	6-1 1/X		2-9 3/18	1"-4 13/18"	1'-2"	0.072	0.072
30"	1'-0"	4'-6"	1'-7 3/4"	6-13/4	5"-0"	3'-1"	1-81/2	1'-3"	0.084	0.084
364	1'-3"	8-3	2-103/4	6-13/4	6,−0,	1-11 13/11°	2-0 5/16"	1'-8"	0.096	0.098
42"	1'-6"	5'-3"	Z'-11"	8'-2°	6'-6°	F-8 7/8"	2-3 1/2	1"-10"	0.108	0.108
48"	2'-0"	6'-0"	2'-2"	8-2"	7-0"	6-8 1/2	2-4 1/2	1'-10"	0.120	0.120
84"	2'-3"	5'-5"	2'-11"	8'-4"	7-6"	8-8 1/2	2-9 1/6"	2'-0"	0.132	0.132
60*	2'-6"	5-0°	3-3	5-3	E-0"	6-0 1/Z	7-0 11/11	2'-0"	0.166	0.144

FLARED END SECTION

NORMAND THIBEAULY, JR., P.E. No. 22834 DATE

11/02/2020	PER ENGINEERING REVIEW
10/29/2020	SIGNAGE PER CIDOT COMMENTS
10/21/2020	ADDED EXISTING & PROPOSED DRIVENAY CULVERT
DATE	DESCRIPTION

DETAIL SHEET No. 2

PREPARED FOR


WESTVIEW LAND COMPANY

39 THOMPSON PIKE (ROUTE 21) & 137 WARE ROAD KILLINGLY, CONNECTICUT



Civil Engineering & Surveying

DATE: 7/16/2020	DRAWN: AMR
SCALE: NOT TO SCALE	DESIGN: NET
SHEET: 8 OF 8	CHK BY:
DWG. No: CLIENT FILE	JOB No: 20013

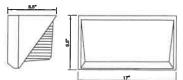

STORM DRAIN PIPE IN TRENCH DETAIL

LIGHT POLE DETAIL

4" LOAM AND SEED FINISHED GRADE

- BACKFILL WITH APPROVE MATERIALS THOROUGHLY DAMPED IN LAYERS AS SPECIFIED

THE APPLICANT WILL CONTACT THE KILLINGLY INLAND WETLANDS AND WATERCOURSES COMMISSION'S AGENT AFTER ALL FROSION AND SEDIMENT CONTROL MEASURES ARE INSTALLED, PRIOR TO ANY CONSTRUCTION OR EXCAVATION ON THE PROPERTY.



300 BOSTWICK AVENUE BRIDGEPORT CONNECTICUT 06605 TEL: (203) 334-6888 FAX: (203) 576-0144

National Pollutant Discharge Elimination System (NPDES)

#21-1257

PROPOSED ERISION AND SEDIMENTATION CONTROL MEASURES

Danielson Airport Killingly, CT 06241

AIP Project No. 3-09-0900-XXX-2020
REHIBILITATE RUNWAY 13-31, TAXIWAY 'A'
AND 'B' (BASE BID)
REPLACE AIRFIELD LIGHTING AND SIGNS
(ADD ALT NO. 2)

