

- 1. THIS MAP AND SURVEY HAVE BEEN PREPARED IN ACCORDANCE WITH SECTIONS 20-300b-1 THRU 20-300b-20 OF THE REGULATIONS OF CONNECTICUT STATE AGENCIES -"STANDARDS FOR SURVEYS AND MAPS IN THE STATE OF CONNECTICUT" AS ADOPTED BY THE CONNECTICUT ASSOCIATION OF LAND SURVEYORS, INC. IT IS A PERIMETER SURVEY BASED ON A FIRST SURVEY AND ORIGINAL SURVEY CONFORMING TO HORIZONTAL ACCURACY CLASS A-2.
- 2. REFERENCE IS MADE TO THE FOLLOWING MAPS:
- A. "IMPROVEMENT LOCATION SURVEY SHOWING EXISTING CONDITIONS PREPARED FOR NETWORK EQUIPMENT SERVICES, LLC - 547 WESTCOTT ROAD (SR607) - KILLINGLY, CONNECTICUT - DATE: 7/05/2016 - SCALE: 1"=50' SHEET 1 OF 3 - BY: KILLINGLY ENGINEERING ASSOCIATES"
- B. "CONNECTICUT STATE HIGHWAY DEPARTMENT RIGHT OF WAY MAP TOWN OF KILLINGLY - DANIELSON-SO. KILLINGLY ROAD FROM STEARNS STREET SOUTHEASTERLY TO SOUTH KILLINGLY - ROUTE U.S.6 - SCALE: 1"=40' - NUMBER 68-04 - SHEETS 3 AND 4 OF 5 -DATED: AUG. 31, 1936"
- C. "PLAN OF LAND OF STATE OF CONNECTICUT KNOWN AS TETREAULT POND IN THE TOWN OF KILLINGLY, CONN. - SCALE: 1"=200' - APR. 1, 1959 - WILLIAM W. PIKE, SURVEYOR"
- 3. DEED REFERENCE: VOL. 1327, PG. 564 OF THE KILLINGLY LAND RECORDS.
- 4. SUBJECT PARCEL IS SHOWN AS MAP 218, LOT 8 OF THE TOWN OF KILLINGLY ASSESSOR'S MAPS.
- 5. ZONING DISTRICT: RURAL DEVELOPMENT
- 6. THE EXISTING SEPTIC SYSTEM LOCATION IS BASED ON INFORMATION SUPPLIED BY THE PROPERTY OWNER.
- 7. THE WETLANDS WERE FIELD DELINEATED BY JOSEPH R. THEROUX, CPSS ON 5/21/2021.

SURVEYING . MAPPING . PLOT PLANS PERIMETER SURVEY MAP OF PROPOSED LOT SPLIT PREPARED FOR CLIFFORD R. LAROSE

HALLS HILL ROAD


SCALE: 1" = 40'


63 SNAKE MEADOW RD KILLINGLY, CT 06239 KILLINGLY, CONNECTICUT DATE: AUGUST 2021

SHEET NO: 1 OF 1 REVISED:

860 774 6230

DRAWN BY: P.A.T. MAP NO: JOB NO: 21019 | F.B. NO: 227

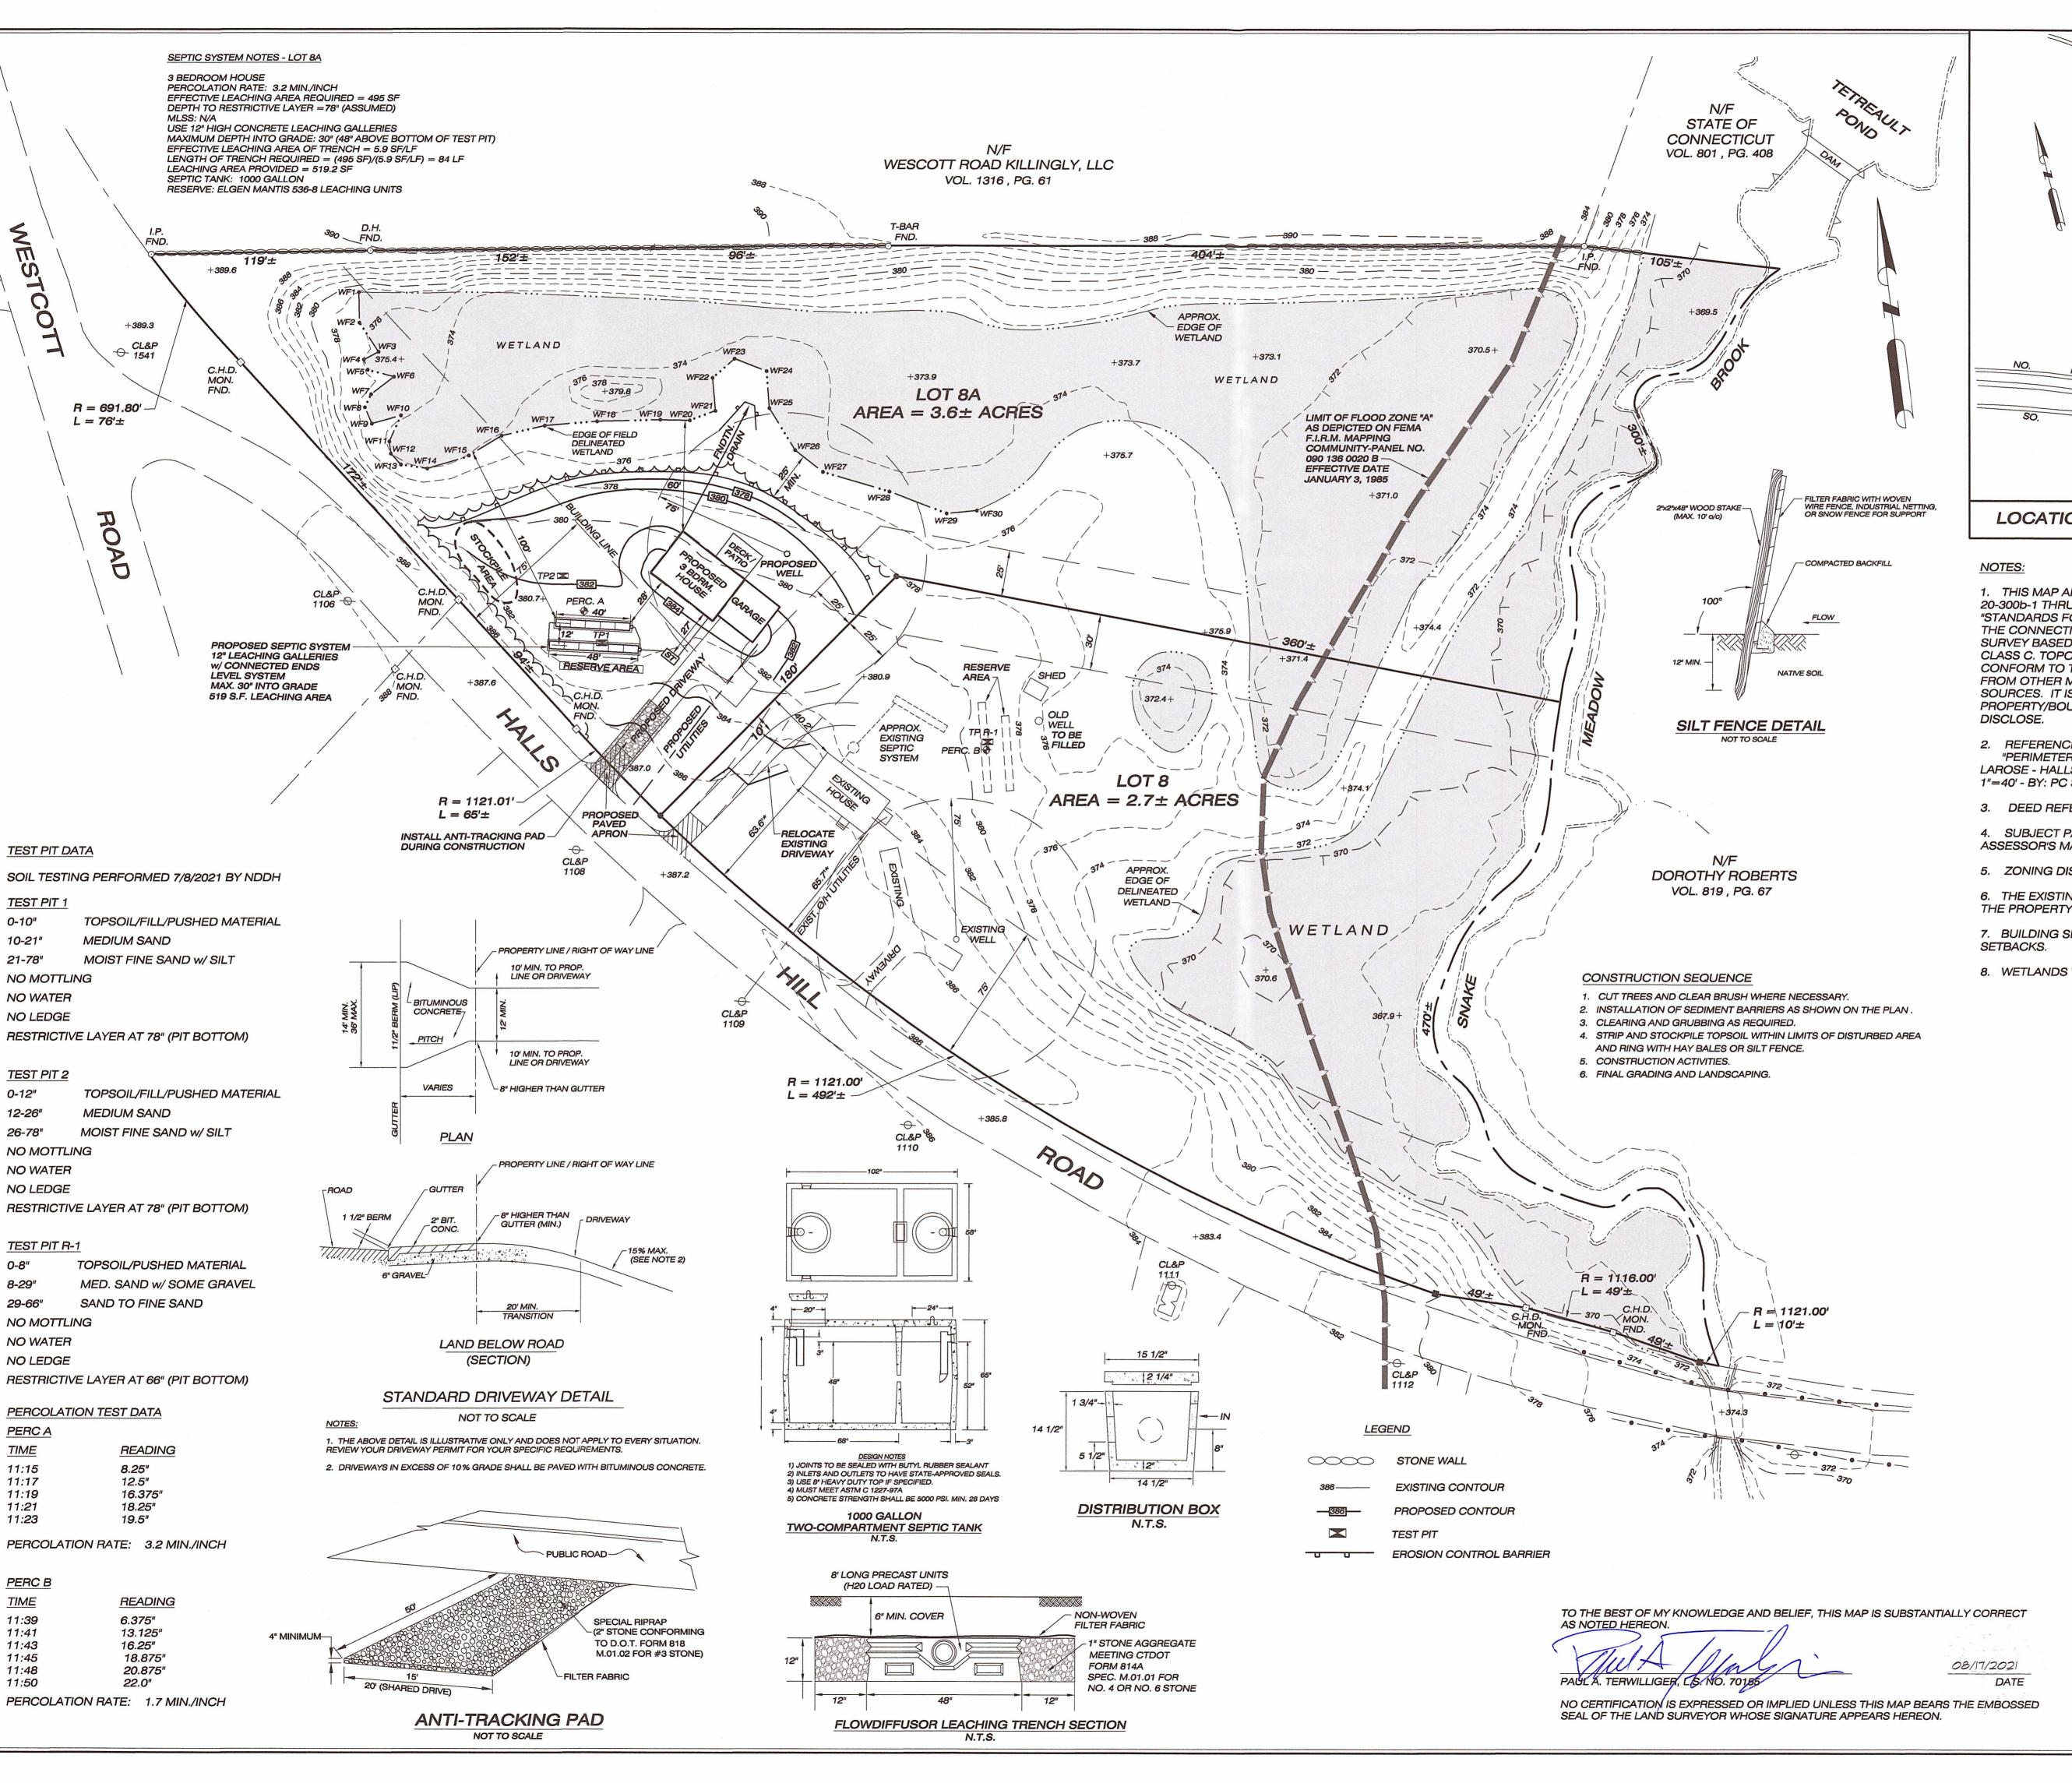

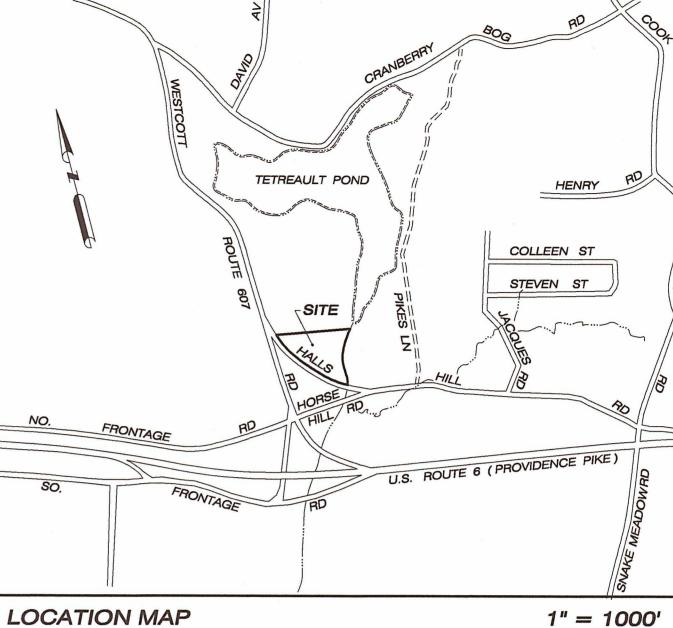

- 1. THIS MAP AND SURVEY HAVE BEEN PREPARED IN ACCORDANCE WITH SECTIONS 20-300b-1 THRU 20-300b-20 OF THE REGULATIONS OF CONNECTICUT STATE AGENCIES -"STANDARDS FOR SURVEYS AND MAPS IN THE STATE OF CONNECTICUT" AS ADOPTED BY THE CONNECTICUT ASSOCIATION OF LAND SURVEYORS, INC. IT IS A GENERAL LOCATION SURVEY BASED ON A DEPENDENT RESURVEY CONFORMING TO HORIZONTAL ACCURACY CLASS C. TOPOGRAPHIC FEATURES WERE TAKEN FROM THE KILLINGLY GIS AND CONFORM TO TOIPOGRAPHIC ACCURACY CLASS T-D. THIS MAP HAS BEEN PREPARED FROM OTHER MAPS, RECORD RESEARCH, LIMITED FIELD MEASUREMENTS AND OTHER SOURCES. IT IS NOT TO BE CONSTRUED AS A PROPERTY/BOUNDARY OR LIMITED PROPERTY/BOUNDARY SURVEY AND IS SUBJECT TO SUCH FACTS AS SAID SURVEYS MAY
- REFERENCE IS MADE TO THE FOLLOWING MAP: "PERIMETER SURVEY - MAP OF PROPOSED LOT SPLIT PREPARED FOR CLIFFORD R. LAROSE - HALLS HILL ROAD, KILLINGLY, CONNECTICUT - DATE: AUGUST 2021 - SCALE: 1"=40' - BY: PC SURVEY ASSOCIATES, LLC"
- 3. DEED REFERENCE: VOL. 1327, PG. 564 OF THE KILLINGLY LAND RECORDS.
- 4. SUBJECT PARCELS ARE SHOWN AS MAP 218, LOT 8 OF THE TOWN OF KILLINGLY ASSESSOR'S MAPS.
- 5. ZONING DISTRICT: RURAL DEVELOPMENT
- 6. THE EXISTING SEPTIC SYSTEM LOCATION IS BASED ON INFORMATION SUPPLIED BY THE PROPERTY OWNER.
- 7. BUILDING SETBACK DIMENSIONS SHOWN WITH * ARE EXISTING NON-CONFORMING
- 8. WETLANDS WERE FIELD DELINEATED BY JOSEPH R. THEROUX, CPSS, MAY 2021.

SOIL EROSION CONTROL

OPERATIONS AND MAINTENANCE

- 1. ALL PROPOSED WORK SHALL CONFORM TO "2002 CONNECTICUT GUIDELINES FOR SOIL EROSION AND SEDIMENT CONTROL" BY THE CONNECTICUT COUNCIL OF SOIL AND WATER CONSERVATION AND TOWN REGULATIONS.
- 2. THE CONTRACTOR SHALL PLAN ALL LAND DISTURBING ACTIVITIES IN A MANNER AS TO MINIMIZE THE EXTENT OF DISTURBED AREAS.
- 3. PRIOR TO CONSTRUCTION OR EXCAVATION, SEDIMENT BARRIERS SHALL BE INSTALLED IN LOCATIONS AS SHOWN ON THE PLAN OR AS REQUIRED BY THE
- TOWN AND MAINTAINED THROUGHOUT CONSTRUCTION. 4. DAILY INSPECTIONS SHALL BE MADE OF EROSION AND SEDIMENT CONTROL MEASURES TO INSURE EFFECTIVENESS AND IMMEDIATE CORRECTIVE ACTION
- SHALL BE TAKEN IF FAILURE OCCURS. 5. EROSION AND SEDIMENT CONTROL MEASURES SHALL REMAIN IN PLACE UNTIL DISTURBED AREAS HAVE BEEN STABILIZED AND VEGETATIVE COVER HAS BEEN
- ESTABLISHED. 6. DISTURBED AREAS SHALL BE FINAL GRADED AS SOON AS POSSIBLE AFTER EXCAVATION. FINAL GRADING SHALL INCLUDE REMOVAL OF LARGE ROCKS, STUMPS AND OTHER DEBRIS FROM THE FINISHED SURFACE. UPON FINAL GRADING, DISTURBED AREAS SHALL BE LOAMED AND SEEDED WITH PERENNIAL FINE TEXTURED GRASSES.
- IMMEDIATELY AFTER SEEDING, MULCH THE SEEDED AREA WITH HAY OR STRAW. 7. IT SHALL BE THE RESPONSIBILITY OF THE CONTRACTOR TO IMPLEMENT THIS EROSION AND SEDIMENT CONTROL PLAN.

