

1'' = 200'

TOTAL SUBDIVIDED AREA = 7.31 ACRES
RURAL DEVELOPMENT ZONING DISTRICT
SUBJECT PARCEL: MAP 254, LOT 6

PARCEL HISTORY MAP

APPROVED BY THE KILLINGLY INLAND WETLANDS & WATERCOURSES COMMISSION CHAIRMAN DATE

APPROVED BY THE KILLINGLY PLANNING & ZONING COMMISSION

CHAIRMAN


DATE


PER SECTION 8-26c OF THE CONNECTICUT GENERAL STATUTES, AMENDED,
APPROVAL AUTOMATICALLY EXPIRES _____ IF ALL PHYSICAL IMPROVEMENTS
REQUIRED BY THIS PLAN ARE NOT COMPLETED BY THAT DATE


SUBDIVISION OF LAND OF PASAY DEVELOPMENT, LLC

325 SNAKE MEADOW ROAD KILLINGLY, CONNECTICUT AUGUST 2023

REVISED 11/6/2023

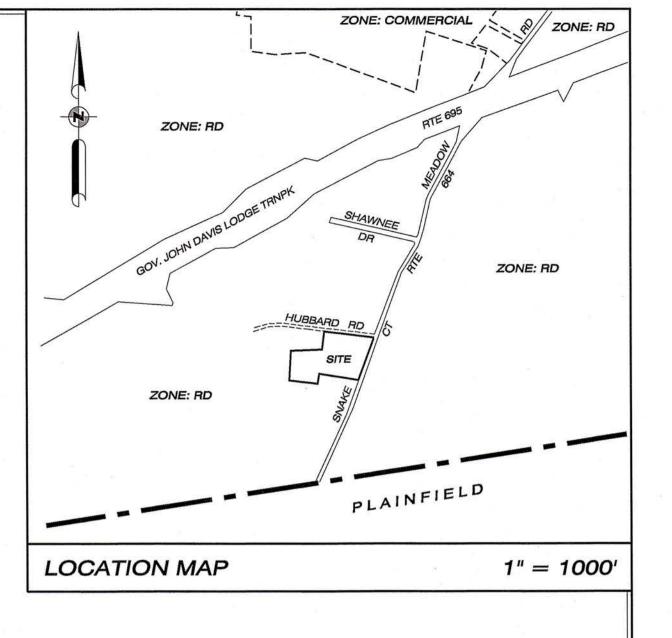

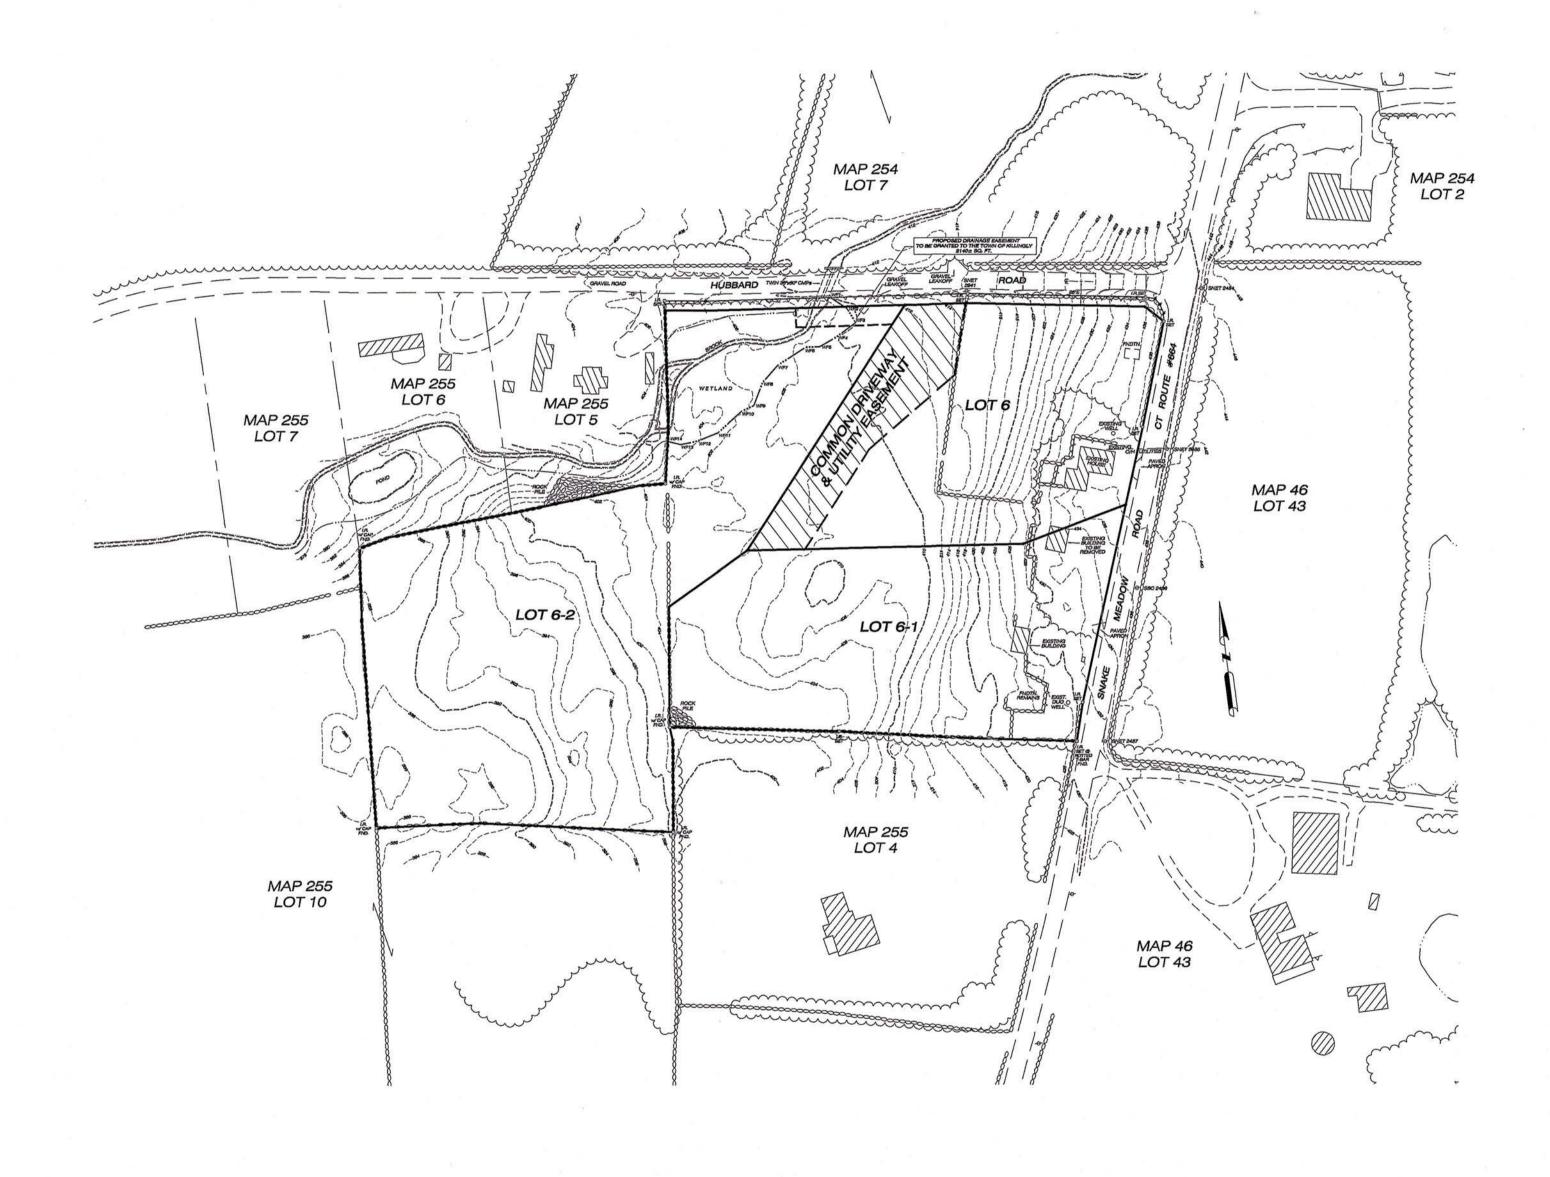

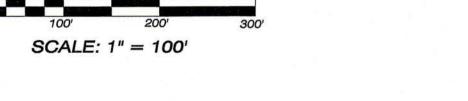

SURVEYOR: PC SURVEY ASSOCIATES, LLC
63 SNAKE MEADOW ROAD
KILLINGLY, CT 06239

ENGINEER: NORMAND THIBEAULT, P.E.

KILLINGLY ENGINEERING ASSOCIATES


DANIELSON, CT 06239

NOV 0 6 2023

PLANNING & ZONING DEPT.
TOWN OF KILLINGLY

OWNER/APPLICANT: PASAY DEVELOPMENT, LLC
162 MAIN STREET
DANIELSON, CT 6239

SHEET INDEX	
SHEET 1	COVER SHEET
SHEET 2	SUBDIVISION MAP
SHEET 3	LOT DEVELOPMENT PLAN
SHEET 4	EROSION CONTROL & CONSTRUCTION DETAILS

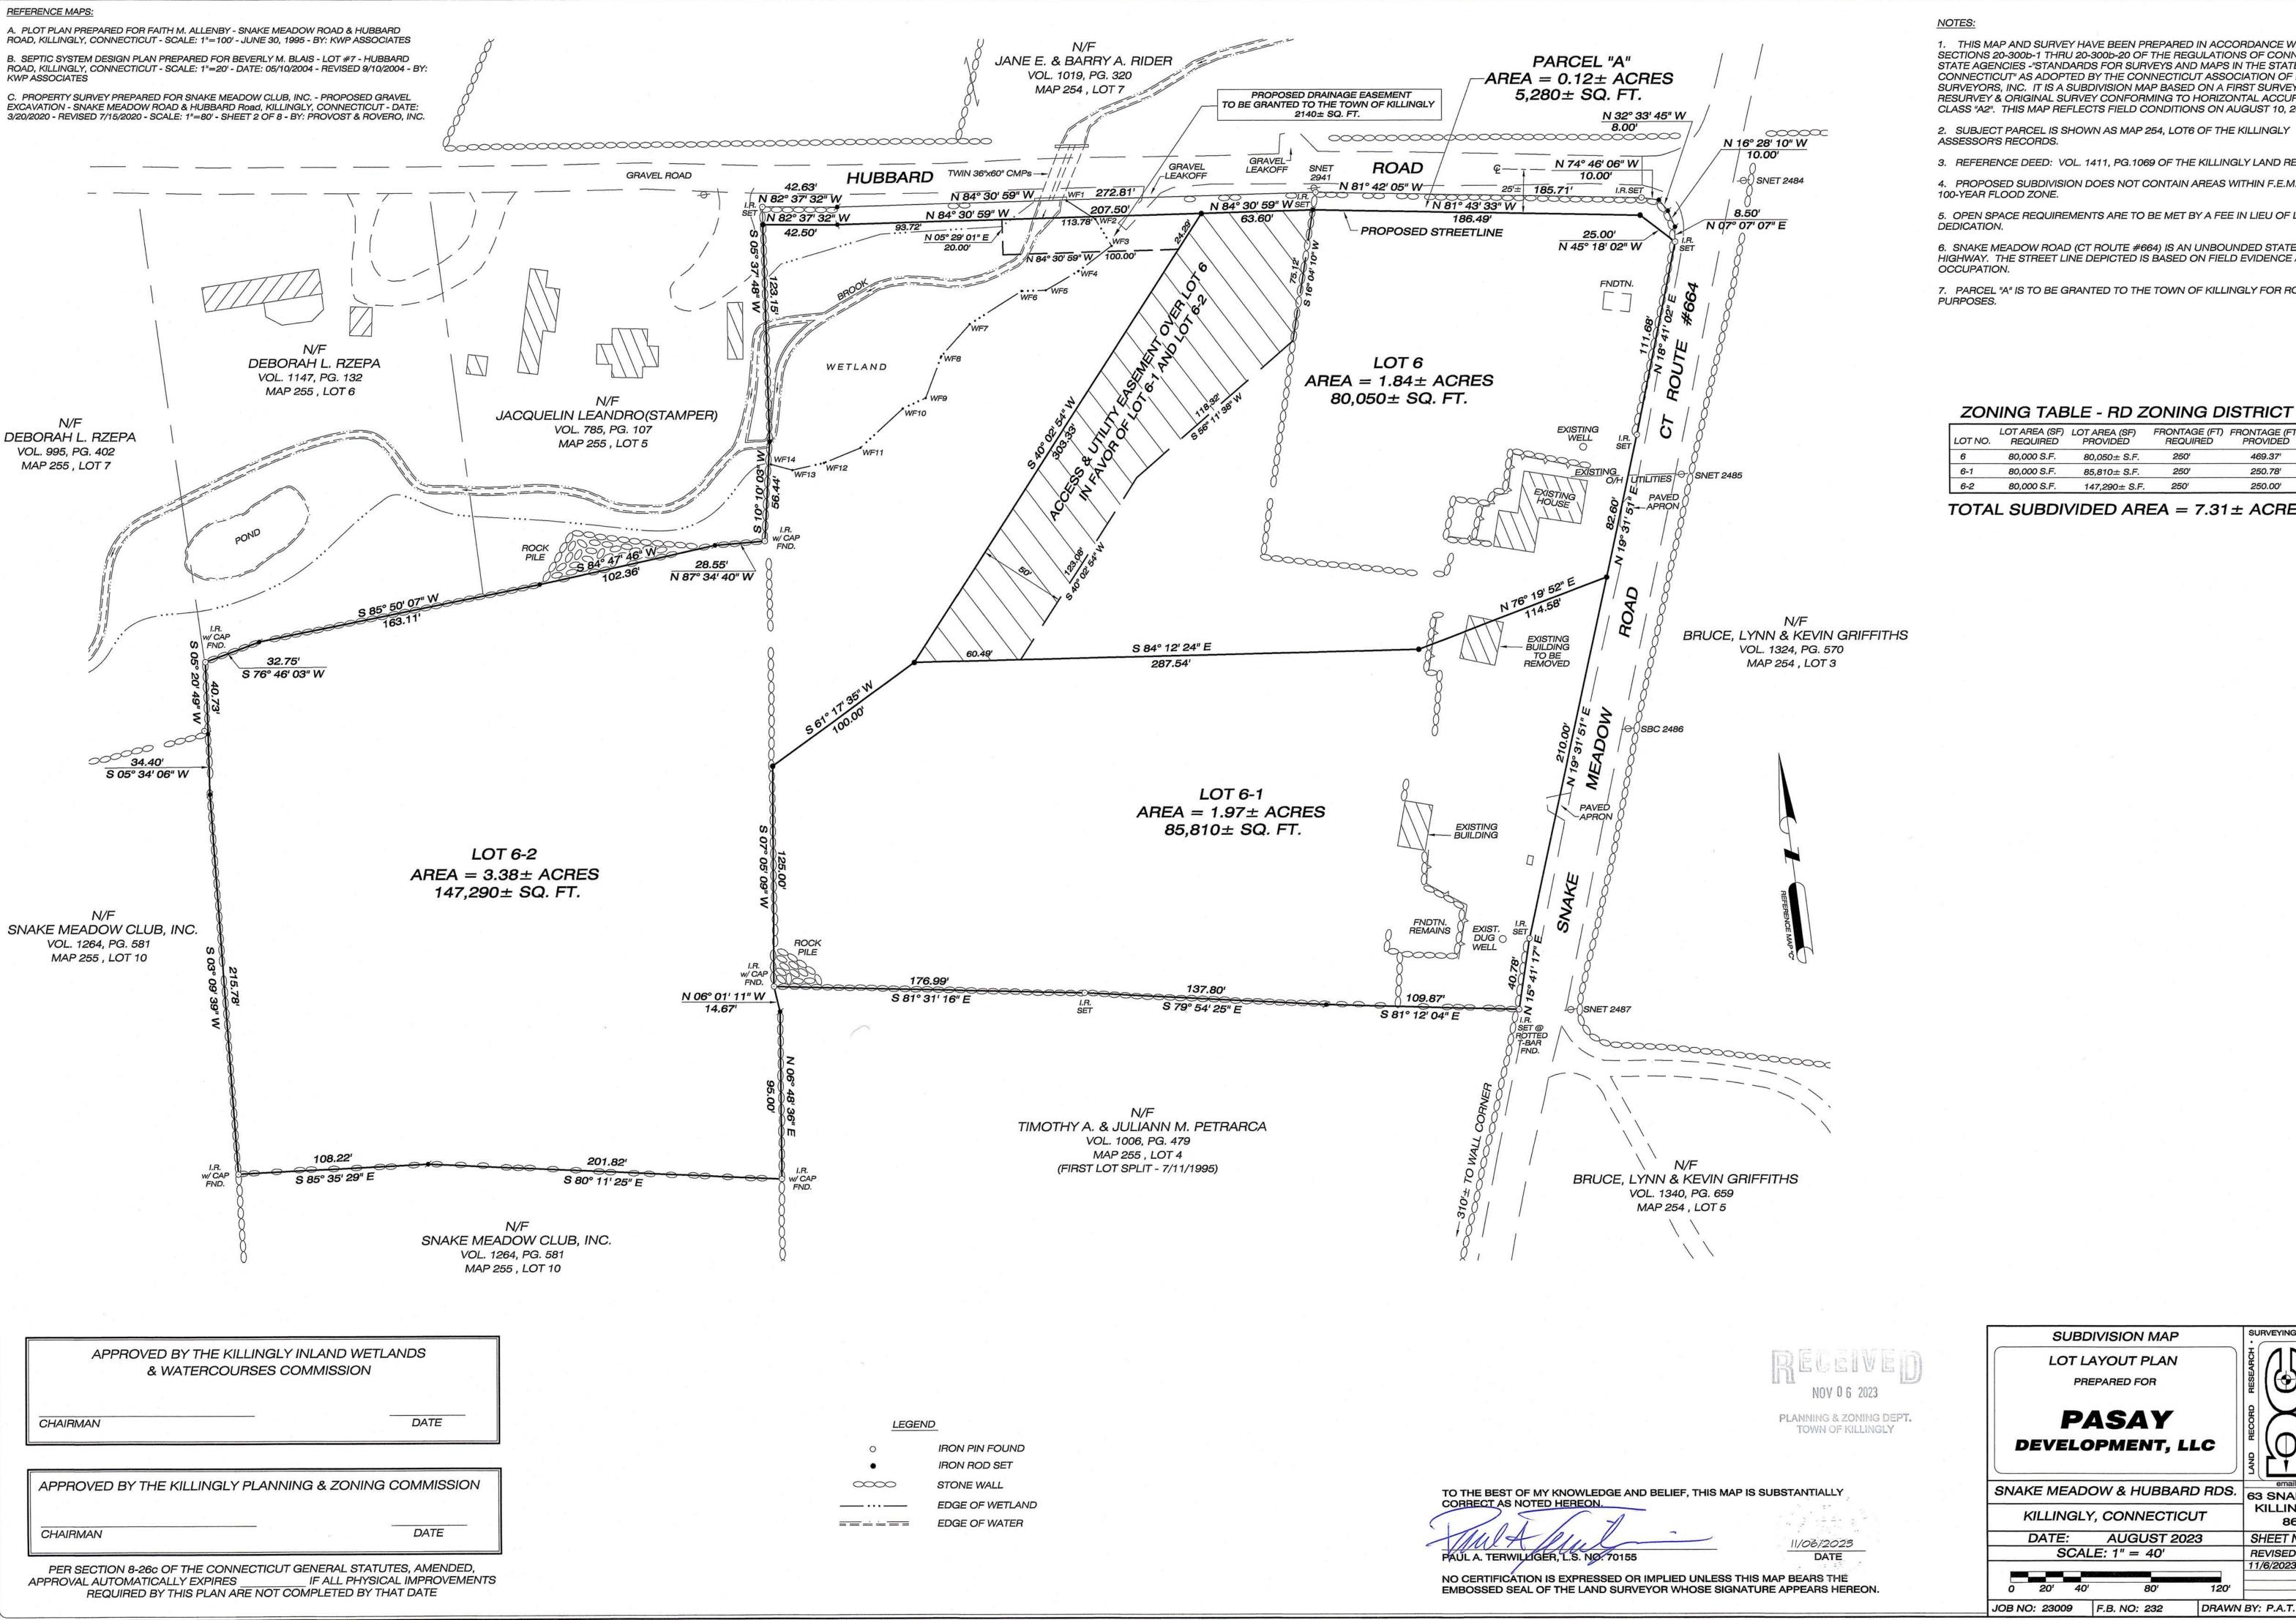

1. THIS MAP AND SURVEY HAVE BEEN PREPARED IN ACCORDANCE WITH SECTIONS 20-300b-1 THRU 20-300b-20 OF THE REGULATIONS OF CONNECTICUT STATE AGENCIES -"STANDARDS FOR SURVEYS AND MAPS IN THE STATE OF CONNECTICUT" AS ADOPTED BY THE CONNECTICUT ASSOCIATION OF LAND SURVEYORS, INC. IT IS A SUBDIVISION MAP BASED ON A FIRST SURVEY, RESURVEY & ORIGINAL SURVEY CONFORMING TO HORIZONTAL ACCURACY CLASS "A2". THIS MAP REFLECTS FIELD CONDITIONS ON AUGUST 10, 2023.

2. SUBJECT PARCEL IS SHOWN AS MAP 254, LOT6 OF THE KILLINGLY

3. REFERENCE DEED: VOL. 1411, PG.1069 OF THE KILLINGLY LAND RECORDS.

4. PROPOSED SUBDIVISION DOES NOT CONTAIN AREAS WITHIN F.E.M.A.

5. OPEN SPACE REQUIREMENTS ARE TO BE MET BY A FEE IN LIEU OF LAND

6. SNAKE MEADOW ROAD (CT ROUTE #664) IS AN UNBOUNDED STATE HIGHWAY. THE STREET LINE DEPICTED IS BASED ON FIELD EVIDENCE AND

7. PARCEL "A" IS TO BE GRANTED TO THE TOWN OF KILLINGLY FOR ROADWAY

LOT NO.	LOT AREA (SF) REQUIRED	LOT AREA (SF) PROVIDED	FRONTAGE (FT) REQUIRED	FRONTAGE (FT) PROVIDED
6	80,000 S.F.	80,050± S.F.	250'	469.37'
6-1	80,000 S.F.	85,810± S.F.	250'	250.78'
6-2	80,000 S.F.	147,290± S.F.	250'	250.00'


TOTAL SUBDIVIDED AREA = $7.31 \pm ACRES$

63 SNAKE MEADOW RD KILLINGLY, CT 06239 860 774 6230 SHEET NO: 2 OF 4 REVISED:

SURVEYING . MAPPING . PLOT PLANS

1/6/2023 - TOWN COMMENTS

DRAWN BY: P.A.T. MAP NO:

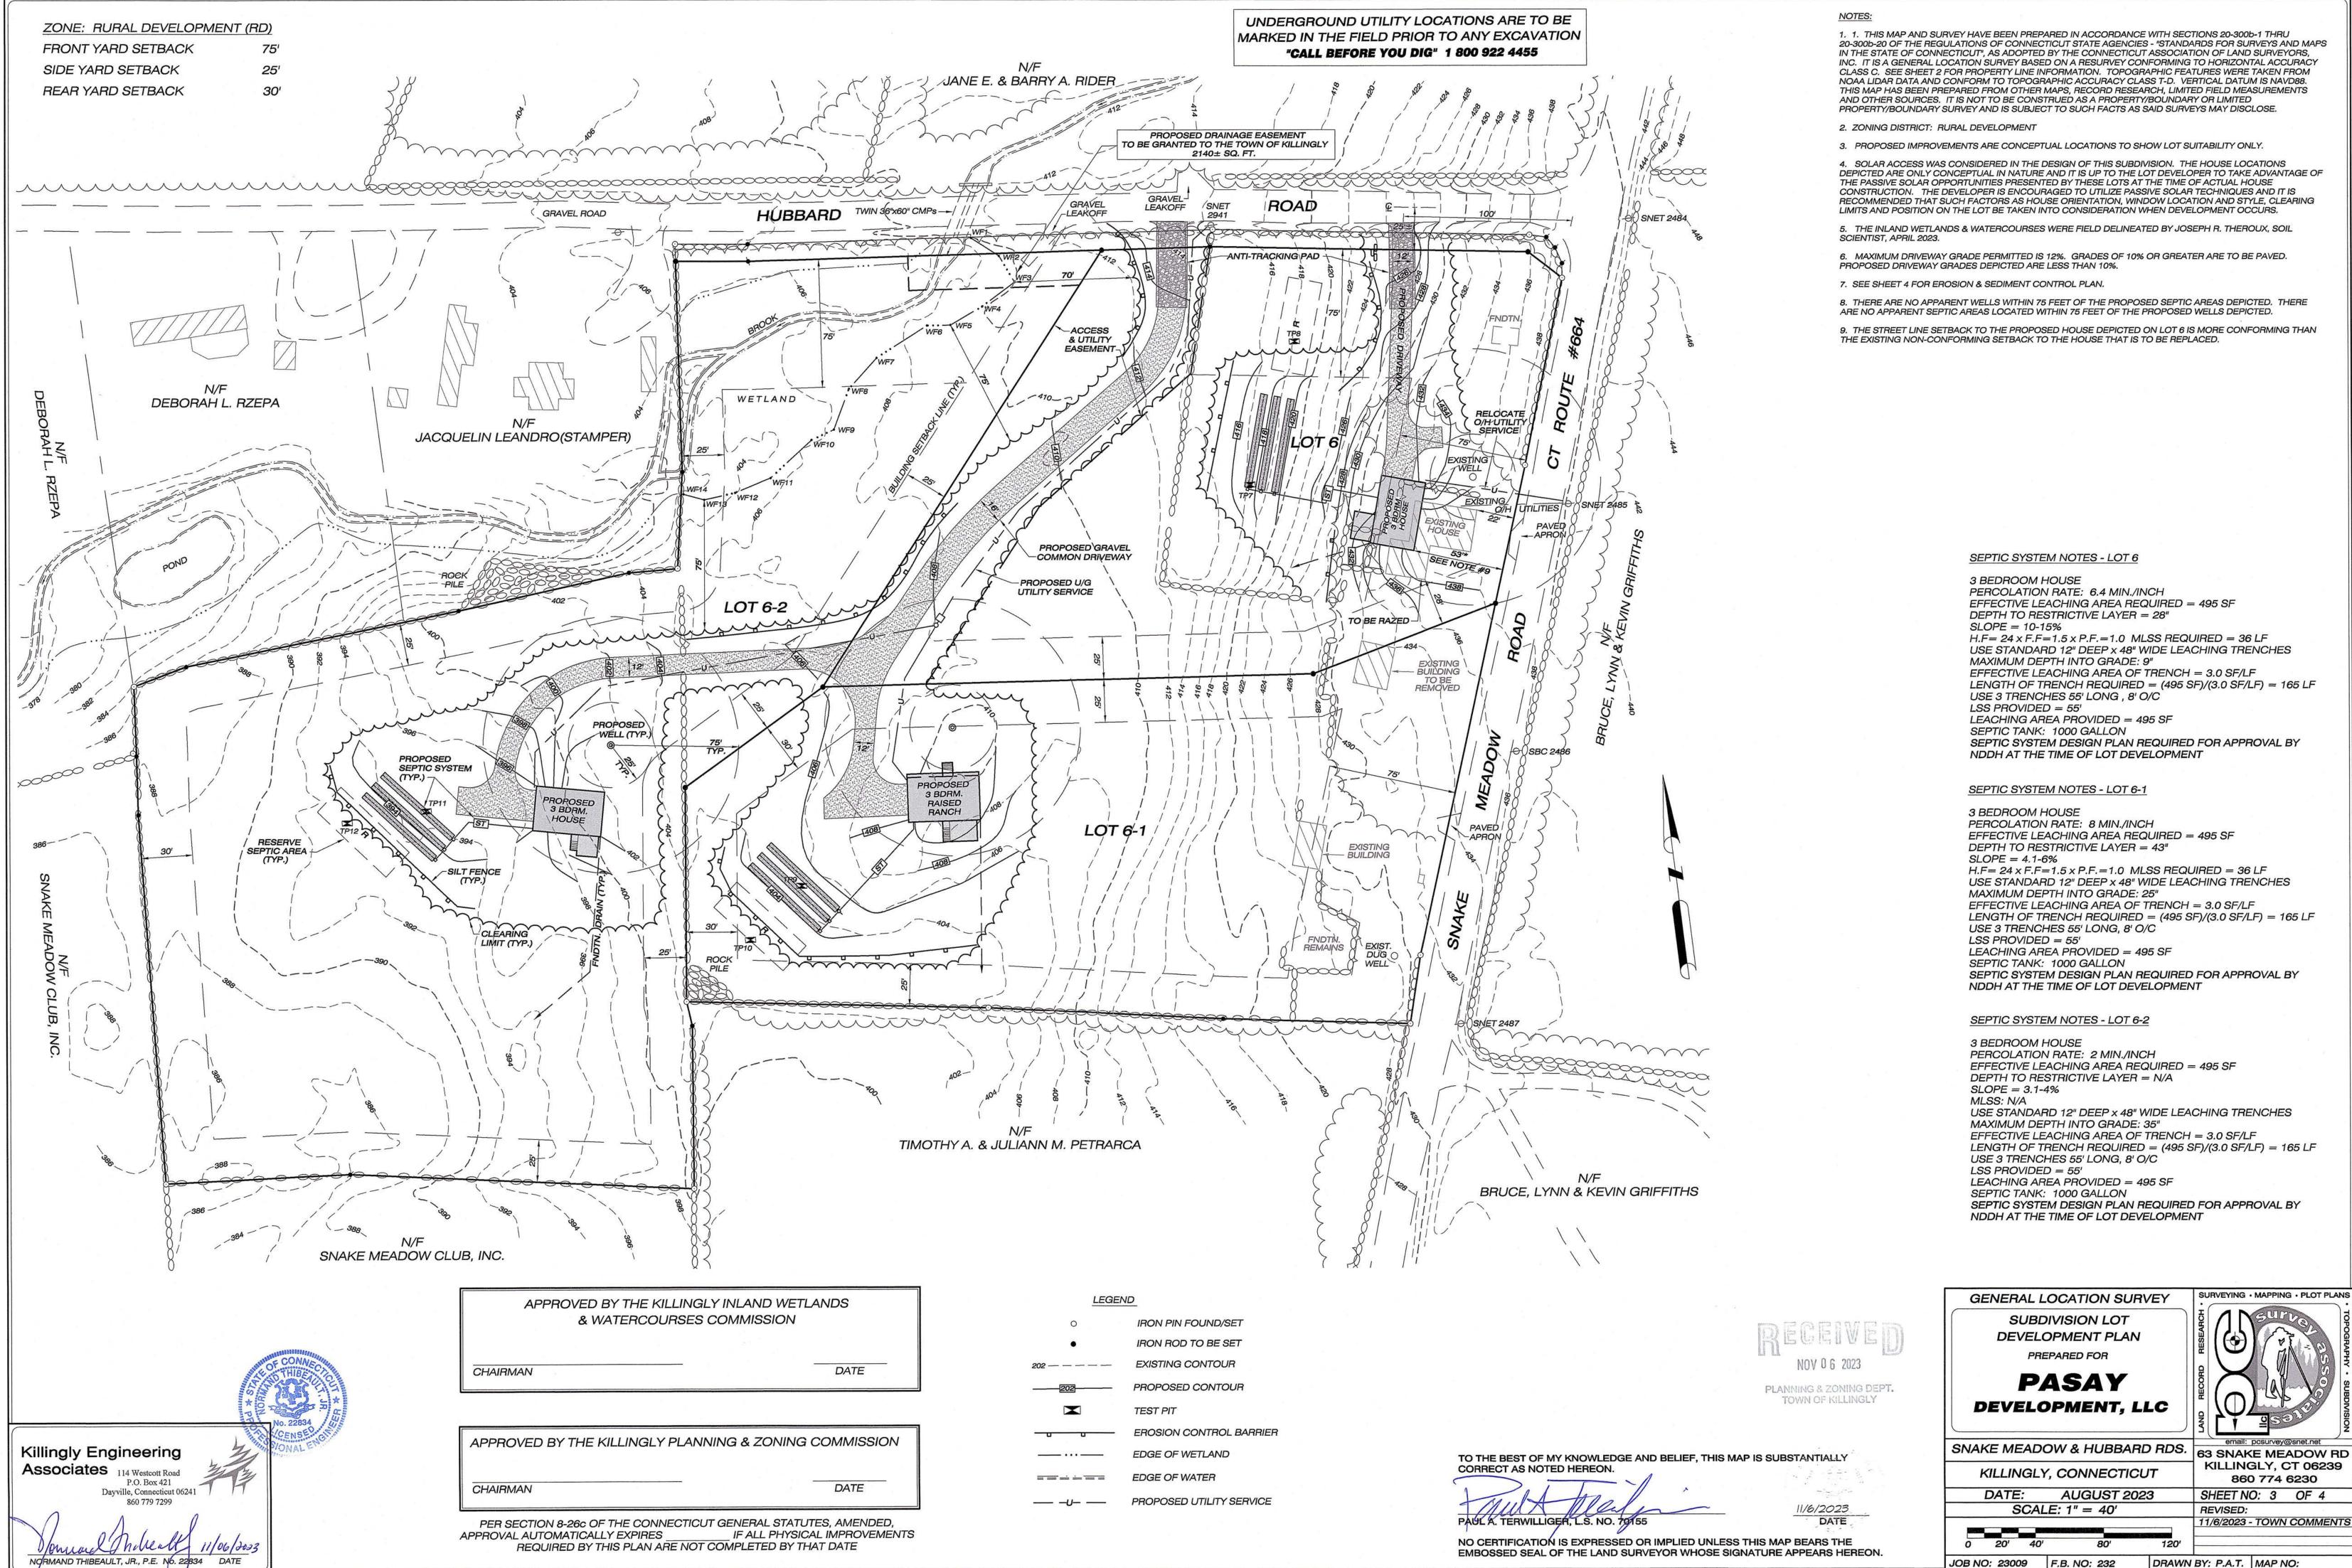

1. 1. THIS MAP AND SURVEY HAVE BEEN PREPARED IN ACCORDANCE WITH SECTIONS 20-300b-1 THRU 20-300b-20 OF THE REGULATIONS OF CONNECTICUT STATE AGENCIES - "STANDARDS FOR SURVEYS AND MAPS IN THE STATE OF CONNECTICUT", AS ADOPTED BY THE CONNECTICUT ASSOCIATION OF LAND SURVEYORS, INC. IT IS A GENERAL LOCATION SURVEY BASED ON A RESURVEY CONFORMING TO HORIZONTAL ACCURACY CLASS C. SEE SHEET 2 FOR PROPERTY LINE INFORMATION. TOPOGRAPHIC FEATURES WERE TAKEN FROM NOAA LIDAR DATA AND CONFORM TO TOPOGRAPHIC ACCURACY CLASS T-D. VERTICAL DATUM IS NAVD88. THIS MAP HAS BEEN PREPARED FROM OTHER MAPS, RECORD RESEARCH, LIMITED FIELD MEASUREMENTS AND OTHER SOURCES. IT IS NOT TO BE CONSTRUED AS A PROPERTY/BOUNDARY OR LIMITED

3. PROPOSED IMPROVEMENTS ARE CONCEPTUAL LOCATIONS TO SHOW LOT SUITABILITY ONLY.

4. SOLAR ACCESS WAS CONSIDERED IN THE DESIGN OF THIS SUBDIVISION. THE HOUSE LOCATIONS DEPICTED ARE ONLY CONCEPTUAL IN NATURE AND IT IS UP TO THE LOT DEVELOPER TO TAKE ADVANTAGE OF THE PASSIVE SOLAR OPPORTUNITIES PRESENTED BY THESE LOTS AT THE TIME OF ACTUAL HOUSE CONSTRUCTION. THE DEVELOPER IS ENCOURAGED TO UTILIZE PASSIVE SOLAR TECHNIQUES AND IT IS RECOMMENDED THAT SUCH FACTORS AS HOUSE ORIENTATION, WINDOW LOCATION AND STYLE, CLEARING LIMITS AND POSITION ON THE LOT BE TAKEN INTO CONSIDERATION WHEN DEVELOPMENT OCCURS.

5. THE INLAND WETLANDS & WATERCOURSES WERE FIELD DELINEATED BY JOSEPH R. THEROUX, SOIL

6. MAXIMUM DRIVEWAY GRADE PERMITTED IS 12%. GRADES OF 10% OR GREATER ARE TO BE PAVED.

8. THERE ARE NO APPARENT WELLS WITHIN 75 FEET OF THE PROPOSED SEPTIC AREAS DEPICTED. THERE ARE NO APPARENT SEPTIC AREAS LOCATED WITHIN 75 FEET OF THE PROPOSED WELLS DEPICTED.

9. THE STREET LINE SETBACK TO THE PROPOSED HOUSE DEPICTED ON LOT 6 IS MORE CONFORMING THAN

SEPTIC SYSTEM NOTES - LOT 6

PERCOLATION RATE: 6.4 MIN./INCH EFFECTIVE LEACHING AREA REQUIRED = 495 SF DEPTH TO RESTRICTIVE LAYER = 28" $H.F = 24 \times F.F = 1.5 \times P.F. = 1.0 MLSS REQUIRED = 36 LF$ USE STANDARD 12" DEEP x 48" WIDE LEACHING TRENCHES MAXIMUM DEPTH INTO GRADE: 9" EFFECTIVE LEACHING AREA OF TRENCH = 3.0 SF/LF LENGTH OF TRENCH REQUIRED = (495 SF)/(3.0 SF/LF) = 165 LF USE 3 TRENCHES 55' LONG, 8' O/C LEACHING AREA PROVIDED = 495 SF SEPTIC TANK: 1000 GALLON SEPTIC SYSTEM DESIGN PLAN REQUIRED FOR APPROVAL BY NDDH AT THE TIME OF LOT DEVELOPMENT

SEPTIC SYSTEM NOTES - LOT 6-1

PERCOLATION RATE: 8 MIN./INCH EFFECTIVE LEACHING AREA REQUIRED = 495 SF DEPTH TO RESTRICTIVE LAYER = 43" $H.F = 24 \times F.F = 1.5 \times P.F. = 1.0$ MLSS REQUIRED = 36 LF USE STANDARD 12" DEEP x 48" WIDE LEACHING TRENCHES MAXIMUM DEPTH INTO GRADE: 25" EFFECTIVE LEACHING AREA OF TRENCH = 3.0 SF/LF LENGTH OF TRENCH REQUIRED = (495 SF)/(3.0 SF/LF) = 165 LF USE 3 TRENCHES 55' LONG, 8' O/C LEACHING AREA PROVIDED = 495 SF SEPTIC TANK: 1000 GALLON SEPTIC SYSTEM DESIGN PLAN REQUIRED FOR APPROVAL BY NDDH AT THE TIME OF LOT DEVELOPMENT

SEPTIC SYSTEM NOTES - LOT 6-2

PERCOLATION RATE: 2 MIN./INCH EFFECTIVE LEACHING AREA REQUIRED = 495 SF DEPTH TO RESTRICTIVE LAYER = N/A USE STANDARD 12" DEEP x 48" WIDE LEACHING TRENCHES MAXIMUM DEPTH INTO GRADE: 35" EFFECTIVE LEACHING AREA OF TRENCH = 3.0 SF/LF LENGTH OF TRENCH REQUIRED = (495 SF)/(3.0 SF/LF) = 165 LF USE 3 TRENCHES 55' LONG, 8' O/C LEACHING AREA PROVIDED = 495 SF SEPTIC TANK: 1000 GALLON SEPTIC SYSTEM DESIGN PLAN REQUIRED FOR APPROVAL BY NDDH AT THE TIME OF LOT DEVELOPMENT

SUBDIVISION LOT **DEVELOPMENT PLAN**

PASAY

DEVELOPMENT, LLC

KILLINGLY, CT 06239 860 774 6230

SHEET NO: 3 OF 4 REVISED: 1/6/2023 - TOWN COMMENTS

SURVEYING . MAPPING . PLOT PLANS

DRAWN BY: P.A.T. MAP NO:

ALL EROSION AND SEDIMENT CONTROL MEASURES AND PROCEDURES SHALL CONFORM TO CONNECTICUT GUIDELINES FOR SOIL EROSION AND SEDIMENT CONTROL, MAY 2002.

DEVELOPMENT

PROPOSED DEVELOPMENT WILL CREATE 3 NEW BUILDING LOTS. ACTIVITIES TO INCLUDE CONSTRUCTION OF COMMON AND INDIVIDUAL DRIVEWAYS, HOUSES, SEPTIC SYSTEMS, WELLS, AND SITE GRADING. THE PRIMARY CONCERN OF THIS EROSION & SEDIMENT CONTROL PLAN IS TO PREVENT EXCESSIVE EROSION AND KEEP ERODED SEDIMENT FROM RUNNING OFF SITE OF THE PROPOSED DEVELOPMENT. NO MATERIAL SHALL BE PLACED WITHIN A REGULATED WETLAND AREA EITHER ON OR

CONSTRUCTION SEQUENCE: (INDIVIDUAL LOT DEVELOPMENT)

- 1. INSTALL EROSION AND SEDIMENT CONTROL MEASURES ALONG
- 2. STRIP & STOCKPILE TOPSOIL.
- 3. PROVIDE ANTI TRACKING PAD AND TEMPORARY POWER TO THE SITE.

DOWN SLOPE SIDE OF THE PROPOSED LIMITS OF DISTURBANCE.

- 4. EXCAVATE FOUNDATION AND BEGIN CONSTRUCTION OF RESIDENCE.
- 5. INSTALL SEPTIC SYSTEM AND WELL.
- 6. PROVIDE DRIVEWAY AND UTILITIES TO THE RESIDENCE.
- 7. LOAM, SEED & MULCH DISTURBED AREAS.

8. REMOVE EROSION AND SEDIMENT CONTROL WHEN VEGETATIVE COVER HAS BEEN ESTABLISHED.

GENERAL DEVELOPMENT PLAN

PRIOR TO THE COMMENCEMENT OF OPERATIONS IN ACCORDANCE WITH ANY PERMIT ISSUED BY THE TOWN PLANNING AND ZONING COMMISSION, THE CONTRACTOR SHALL INSTALL ALL EROSION AND SEDIMENT CONTROL DEVICES.

THE CONTRACTOR SHALL OBTAIN A SITE INSPECTION FROM THE TOWN ZONING ENFORCEMENT OFFICER OR WETLANDS AGENT TO ENSURE THAT ALL EROSION AND SEDIMENT CONTROL MEASURES HAVE BEEN INSTALLED IN ACCORDANCE WITH THIS NARRATIVE. UPON APPROVAL WITH RESPECT TO THE INSTALLATION OF EROSION AND SEDIMENT CONTROL MEASURES, THE CONTRACTOR MAY COMMENCE OPERATIONS PURSUANT TO THE PERMIT. EROSION AND SEDIMENT CONTROL DEVICES SHALL BE INSTALLED IN ACCORDANCE WITH THE "SILT FENCE INSTALLATION & MAINTENANCE" AND "HAY BALE INSTALLATION & MAINTENANCE" SECTIONS OF THIS NARRATIVE.

ALL STRIPPING IS TO BE CONFINED TO THE IMMEDIATE CONSTRUCTION AREA. TOPSOIL SHALL BE STOCKPILED SO THAT SLOPES DO NOT EXCEED 2 TO 1. THERE SHALL BE NO BURIAL OF STUMPS. A HAY BALE SEDIMENT BARRIER IS TO SURROUND EACH STOCKPILE AND A TEMPORARY VEGETATIVE COVER PROVIDED IF NECESSARY.

DUST CONTROL WILL BE ACCOMPLISHED BY SPRAYING WITH WATER.

FINAL STABILIZATION OF THE SITE IS TO FOLLOW THE PROCEDURES OUTLINED IN PERMANENT VEGETATIVE COVER. IF NECESSARY A TEMPORARY VEGETATIVE COVER IS TO BE PROVIDED UNTIL A PERMANENT COVER CAN BE APPLIED.

DURING THE STABILIZATION PERIOD, ALL EROSION AND SEDIMENT CONTROL MEASURES SHALL BE MAINTAINED IN PROPER WORKING ORDER. THE CONTRACTOR SHALL BE RESPONSIBLE FOR CHECKING ALL EROSION AND SEDIMENT CONTROL ON A TWICE-WEEKLY BASIS DURING THE STABILIZATION PERIOD AND AFTER EACH STORM EVENT. DURING THE STABILIZATION PERIOD WITH RESPECT TO THE SITE, ANY EROSION WHICH OCCURS WITHIN DISTURBED AREAS SHALL BE IMMEDIATELY REPAIRED. RESEEDED AND RE-ESTABLISHED.

ALL DISTURBED SLOPES SHALL BE STABILIZED WITHIN ONE SEASON (SPRING OR FALL) OF THE COMPLETION OF THE PROJECT BEFORE A CERTIFICATE OF COMPLIANCE WILL BE ISSUED.

ONCE STABILIZATION HAS BEEN COMPLETED AND APPROVED BY THE TOWN ZONING ENFORCEMENT OFFICER AND/OR WETLANDS AGENT. EROSION AND SEDIMENT CONTROL MEASURES SHALL BE REMOVED BY THE CONTRACTOR OR LOT OWNER.

SILT FENCE INSTALLATION AND MAINTENANCE:

- 1. DIG A 6" DEEP TRENCH ON THE UPHILL SIDE OF THE BARRIER LOCATION.
- 2. POSITION THE POSTS ON THE DOWNHILL SIDE OF THE BARRIER AND DRIVE THE POSTS 1.5 FEET INTO THE GROUND.
- 3. LAY THE BOTTOM 6" OF THE FABRIC IN THE TRENCH TO PREVENT UNDERMINING AND BACKFILL.
- 4. INSPECT AND REPAIR BARRIER AFTER HEAVY RAINFALL.
- 5. INSPECTIONS WILL BE MADE AT LEAST ONCE PER WEEK AND WITHIN 24 HOURS OF THE END OF A STORM WITH A RAINFALL AMOUNT OF 0.5 INCH OR GREATER TO DETERMINE MAINTENANCE NEEDS.
- 6. SEDIMENT DEPOSITS ARE TO BE REMOVED WHEN THEY REACH A HEIGHT OF 1 FOOT BEHIND THE BARRIER OR HALF THE HEIGHT OF THE BARRIER AND ARE TO BE DEPOSITED IN AN AREA WHICH IS NOT REGULATED BY THE INLAND WETLANDS COMMISSION.
- 7. REPLACE OR REPAIR THE FENCE WITHIN 24 HOURS OF OBSERVED FAILURE. FAILURE OF THE FENCE HAS OCCURRED WHEN SEDIMENT FAILS TO BE RETAINED BY THE FENCE
- BECAUSE: - THE FENCE HAS BEEN OVERTOPPED, UNDERCUT OR BYPASSED BY RUNOFF WATER,
- THE FENCE HAS BEEN MOVED OUT OF POSITION, OR - THE GEOTEXTILE HAS DECOMPOSED OR BEEN DAMAGED.

HAY BALE INSTALLATION AND MAINTENANCE:

1. BALES SHALL BE PLACED AS SHOWN ON THE PLANS WITH THE ENDS OF THE BALES TIGHTLY ABUTTING EACH OTHER.

2. EACH BALE SHALL BE SECURELY ANCHORED WITH AT LEAST 2 STAKES AND GAPS BETWEEN BALES SHALL BE WEDGED WITH STRAW TO PREVENT WATER FROM PASSING BETWEEN THE BALES.

3. INSPECT BALES AT LEAST ONCE PER WEEK AND WITHIN 24 HOURS OF THE END OF A STORM WITH A RAINFALL AMOUNT OF 0.5 INCHES OR GREATER TO DETERMINE MAINTENANCE

4. REMOVE SEDIMENT BEHIND THE BALES WHEN IT REACHES HALF THE HEIGHT OF THE BALE AND DEPOSIT IN AN AREA WHICH IS NOT REGULATED BY THE INLAND WETLANDS COMMISSION.

5. REPLACE OR REPAIR THE BARRIER WITHIN 24 HOURS OF OBSERVED FAILURE. FAILURE OF THE BARRIER HAS OCCURRED WHEN SEDIMENT FAILS TO BE RETAINED BY THE BARRIER

- BECAUSE: - THE BARRIER HAS BEEN OVERTOPPED, UNDERCUT OR BYPASSED BY RUNOFF WATER,
- THE BARRIER HAS BEEN MOVED OUT OF POSITION, OR
- THE HAY BALES HAVE DETERIORATED OR BEEN DAMAGED.

TEMPORARY VEGETATIVE COVER

A TEMPORARY SEEDING OF RYE GRASS WILL BE COMPLETED WITHIN 15 DAYS OF THE FORMATION OF STOCKPILES. IF THE SOIL HAS BEEN COMPACTED BY CONSTRUCTION OPERATIONS IT SHALL BE LOOSENED TO A DEPTH OF 2 INCHES BEFORE THE FERTILIZER, LIME AND SEED IS APPLIED. 10-10-10 FERTILIZER AT A RATE OF 7.5 POUNDS PER 1000 S.F. LIMESTONE AT A RATE OF 90 LBS. PER 1000 S.F. SHALL BE USED. RYE GRASS APPLIED AT A RATE OF 1 LB. PER 1000 S.F. SHALL PROVIDE THE TEMPORARY VEGETATIVE COVER. STRAW FREE FROM WEEDS AND COARSE MATTER SHALL BE USED AT A RATE OF 70-90 LBS. PER 1000 S.F. AS A TEMPORARY MULCH. APPLY A JUTE NETTING COVER TO SLOPES OF 3:1 OR GREATER SLOPE.


PERMANENT VEGETATIVE COVER


TOPSOIL WILL BE REPLACED ONCE THE EXCAVATION AND FILL PLACEMENT HAS BEEN COMPLETED AND THE SLOPES ARE GRADED TO A SLOPE NO GREATER THAN 2 TO 1. PROVIDE SLOPE PROTECTION ON ALL CUT SLOPES. TOPSOIL WILL BE SPREAD AT A MINIMUM COMPACTED DEPTH OF 4 INCHES. ONCE THE TOPSOIL HAS BEEN SPREAD, ALL STONES TWO INCHES OR LARGER IN ANY DIMENSION WILL BE REMOVED AS WELL AS DEBRIS, APPLY AGRICULTURAL GROUND LIMESTONE AT THE RATE OF TWO TONS PER ACRE OR 100 LBS. PER 1000 S.F. APPLY 10-10-10 FERTILIZER OR EQUIVALENT AT A RATE OF 300 LBS. PER ACRE OR 7.5 LBS. PER S.F. WORK LIMESTONE INTO THE SOIL TO A DEPTH OF 4 INCHES. INSPECT SEEDBED BEFORE SEEDING. IF TRAFFIC HAS COMPACTED THE SOIL, RETILL COMPACTED AREAS. APPLY THE FOLLOWING GRASS SEED MIX:

SEED MIXTURE	LBS./ACRE	LBS./1000 S.F.
KENTUCKY BLUEGRASS	20	0.45
CREEPING RED FESCUE	20	0.45
PERENNIAL RYEGRASS	5	0.10
	45	1.00


THE RECOMMENDED SEEDING DATES ARE: APRIL 1 - JUNE 15 AND AUGUST 1 - SEPTEMBER 15

FOLLOWING SEEDING MULCH WITH WEED FREE STRAW AND APPLY A JUTE NETTING COVER TO AREAS OF 3:1 OR GREATER SLOPE

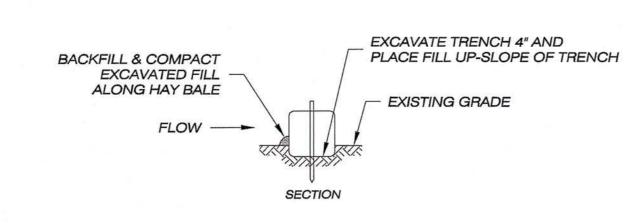

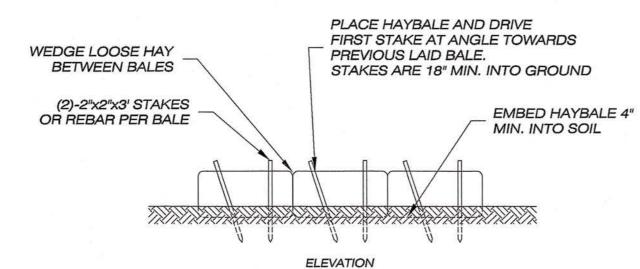

HAY BALE BARRIER DETAIL

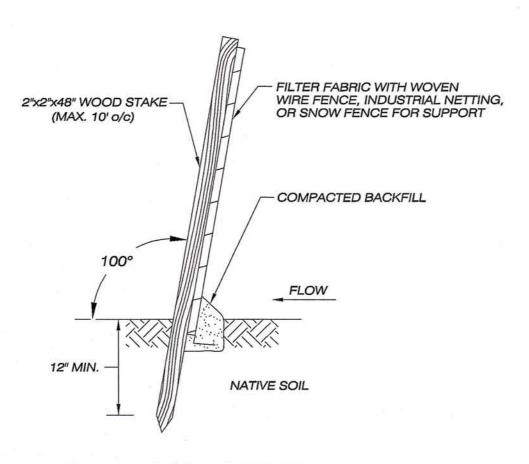

SILT FENCE DETAIL NOT TO SCALE

CHAIRMAN

APPROVAL AUTOMATICALLY EXPIRES


APPROVED BY THE KILLINGLY PLANNING & ZONING COMMISSION

PER SECTION 8-26c OF THE CONNECTICUT GENERAL STATUTES, AMENDED.

REQUIRED BY THIS PLAN ARE NOT COMPLETED BY THAT DATE

DATE

IF ALL PHYSICAL IMPROVEMENTS

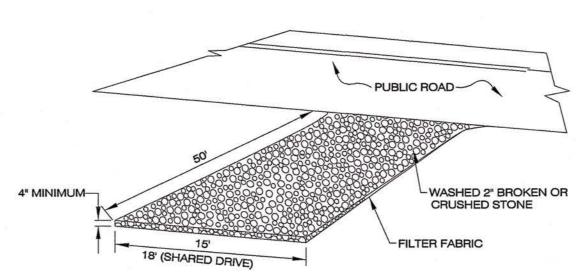

ANTI-TRACKING PAD NOT TO SCALE



JUNK MATERIAL / TOPSOIL / ORGANICS

NO MOTTLING WATER SEEPS AT 84"

TOPSOIL / ORGANICS SILTY SANDY LOAM 6-27" GROUNDWATER

MOTTLING AT 28" WATER AT 77", SEEPS AT 70" NO LEDGE RESTRICTIVE LAYER AT 27"

TP9

0-5" TOPSOIL / ORGANICS RED/BROWN LOAMY SAND TAN SILTY FIONE SAND 43-83"

NO MOTTLING NO WATER

RESTRICTIVE LAYER AT 43"

TP10

TOPSOIL / ORGANICS BONEY MED. SAND

PERC. 'B' PERCOLATION RATE: 8 MIN./INCH AT 26" DEPTH

TP11

0-5" LOAMY SAND TAN/WHITE FINE SAND, SILTY 57-90"

NO MOTTLING NO WATER

LOAMY SAND

BONEY GRAVEL

NO MOTTLING NO WATER NO LEDGE

PERC. 'C' PERCOLATION RATE: 2 MIN./INCH AT 26" DEPTH NOTE: TEST PITS 1 - 6 LOGGED 11-22-2006 - LOCATIONS UNDETERMINED



<u>TP 7</u>

SILTY SANDY LOAM 11-30" GREY SANDY LOAM W/ SOME SMALL ROCKS, MOIST 30-90"

NO LEDGE RESTRICTIVE LAYER AT 30"

TP8

GREYISH SANDY PAN, SOME ROCKS

PERC. 'A' PERCOLATION RATE: 6.4 MIN./INCH AT 26" DEPTH

GREYISH MOD. COMPACT BONEY SANDY PAN

REDDISH/BROWN LOAMY SAND GREY VERY BONEY MED. SAND NO MOTTLING

NO WATER NO LEDGE RESTRICTIVE LAYER AT 68"

BONEY GRAVEL, SOME LRG. ROCKS

NO LEDGE TP12

TOPSOIL / ORGANICS

BONEY GRAVEL W/ VERY LRG. ROCKS/BOULDERS

NOV 0 6 2023 PLANNING & ZONING DEPT. TOWN OF KILLINGLY

EROSION CONTROL PLAN & CONSTRUCTION DETAILS PREPARED FOR

EXISTING GRADE

PASAY DEVELOPMENT, LLC

SUBDIVISION OF LAND

SNAKE MEADOW & HUBBARD RDS. KILLINGLY, CONNECTICUT DATE: AUGUST 2023

F.B. NO: N/A

REVISED:

PROPERTY LINE / RIGHT OF WAY LINE

10' MIN. TO PROP.

10' MIN. TO PROP.

LINE OR DRIVEWAY

4" HIGHER THAN GUTTER

PROPERTY LINE / RIGHT OF WAY LINE

DRIVEWAY

BALES BUTTED TOGETHER

- WEDGE LOOSE STRAW

CREATE A CONTINUOUS

2"x2"x3' LONG STAKES OR REBARS EACH BALE

SURVEYING . MAPPING . PLOT PLANS

63 SNAKE MEADOW RD

KILLINGLY, CT 06239

860 774 6230

SHEET NO: 4 OF 4

(SEE NOTES)

- 4" HIGHER THAN

TRANSITION

GUTTER

10' MIN.

LAND BELOW ROAD

(SECTION)

STANDARD DRIVEWAY DETAIL

NOT TO SCALE

2. DRIVEWAYS IN EXCESS OF 10% GRADE SHALL BE PAVED WITH BITUMINOUS CONCRETE.

SIDE SLOPE BOTTOM OF SWALE SIDE SLOPE

OR STRAW

BOTTOM OF

DRAINAGE WAY

PLAN VIEW

HAYBALE CHECK DAM

NOT TO SCALE

C SWALE

- BITUMINOUS

CONCRETE?

VARIES

CONC.

PITCH

LINE OR DRIVEWAY

APPROVED BY THE KILLINGLY INLAND WETLANDS & WATERCOURSES COMMISSION CHAIRMAN

DATE

FINISHED GRADE

7" BEDDING --

MIN. FROM EDGE OF TRENCH.

THAN 2" MAX. DIMENSION.

ANY DIRECTION.

DETECTABLE

CAUTION TAPE

SUITABLE

BACKFILL

& MATERIAL-

3" MIN. CONDUIT

1. OSHA STANDARDS REQUIRE THAT SPOILS BE PLACED 24"

2. SUITABLE BACKFILL SHALL NOT CONTAIN ASH, CINDER,

3. FUEL OR WATER LINES SHALL BE NO CLOSER THAN 18" IN

UTILITY TRENCH DETAIL

NOT TO SCALE

SHELL, FROZEN MATERIAL, LOOSE DEBRIS OR STONES LARGER

(ELEC., TELE., CTV)

36" MAX. OR

UTILITY CO.

AS REQ'D BY

1-1/2" BERM

NOTES:

6" GRAVEL-

1. MAXIMUM DRIVEWAY GRADE IS 12%

Killingly Engineering Associates 114 Westcott Road P.O. Box 421 Dayville, Connecticut 06241 860 779 7299 orneed uniteall NØRMAND THIBEAULT, JR., P.E./ No. 22834 DATE

SCALE: 1" = AS NOTED

JOB NO: 23009

DRAWN BY: P.A.T. MAP NO: