



**TOWN OF KILLINGLY
INLAND WETLANDS AND WATERCOURSES COMMISSION**

Monday, July 6, 2020

**Regular Meeting
7:00 PM**

AGENDA

Public can view this meeting on Facebook Live.

Go to www.killinglyct.gov and click on Facebook Live at the bottom of the page

RECEIVED
TOWN CLERK, KILLINGLY, CT
2020 JUL -2 AM 11:46
Elizabeth M. Quisior

- I. **CALL TO ORDER**
- II. **ROLL CALL**
- III. **ADOPTION OF MINUTES – (Review/Discussion/Action)**
 - A. April 6, 2020 Regular Meeting Minutes
- IV. **CITIZENS’ PARTICIPATION** – Pursuant to Governor’s Executive Order 7B, all public comment can be emailed to publiccomment@killinglyct.gov or mailed to Town of Killingly, 172 Main Street, Killingly, CT 06239 on or before the meeting. All public comment received prior to the meeting will be posted on the Town’s website www.killinglyct.gov.
- V. **Unfinished Business: – (Review/Discussion/Action)**
 - A. **Application 20-1482 of Patriot Homes LLC** for a 30 lot subdivision; with associated, grading, drainage, utilities; new roadway and stormwater basin within the 200’ upland review area; Located at 215 Hartford Pike; GIS Map 108; Lot 4; 20.761 acres; Low Density Zone.
- VI. **New Business: (listed in order of receipt) – (Review/Discussion/Action)**
 - A. **Application 20-1490 of James & Sheila Ilewicz** for Jurisdictional Ruling Notification of Timber Harvest; Located at 115 Lake Road; GIS Map 83; Lot 1; 50 acres; Rural Development Zone.
Application can be received and acted upon tonight.
 - B. **Application 20-1491 of Town of Killingly** for Jurisdictional Ruling regarding property maintenance (CGS 22a-40-A-4) at Alexzander’s Lake Overlay Zoning District.
Application can be received and acted upon tonight.
 - C. **Application 20-1492 of Dennis Lawlor** for Jurisdictional Ruling regarding property maintenance (CGS 22a-40-A-4); Located at 1460 North Road; GIS Map 44; Lot 1; 1.9 acres; Rural Development Zone. *Application can be received and acted upon tonight.*
 - D. **Application 15-1413 of Snake Meadow Club** for a five (5) year extension from the October 5, 2015 approval of restoration and permitting of a gravel operation, which expires in October 5, 2020 to October 5, 2025; Located at 1460 North Road; GIS Map 44; Lot 1; 1.9 acres; Rural Development Zone. *Application can be received and acted upon tonight.*

If the application is complete the Commission shall decide if a public hearing and/or site walk should be held on each application and continue further action until next month’s meeting. The Commission may also delegate to its duly authorized agent.

VII. Correspondence to the Commission

VIII. Staff Report

- A. Authorized Agent Approvals
- B. Monthly Zoning/Wetlands Report
- C. Appointment of Authorized Agent (with this appointment the Town of Killingly now has three (3) members of Staff who can act as the Inland Wetlands Authorized Agents).
 - 1. Ann-Marie Aubrey, Director of Planning and Development
 - 2. Jonathan Blake, Zoning Enforcement Officer / Planner 1
 - 3. Marina Capraro, Natural Resources Officer / Planning Assistant

IX. Town Council Liaison

X. Adjournment

MOTION #3 (04.06.20): made by Mr. Ruhlemann **SECONDED BY** Vice Chairman Galton that the Inland Wetland and Watercourses approve Application #20-1483, Charles Myers, with the following condition:

1. The applicant work with Town Engineer, David Capacchione, to meet all requirements

VOICE VOTE: UNANIMOUS;

MOTION CARRIED

- b. **Application #20-1485** Raymond Preece for a single family home (first split) ; with associated grading, drainage, utilities and septic and driveway within 200' foot upland review area; with 150' of wetlands disturbance; Located at 126 Ballouville Road; GIS Map 54; Lot 2.1; 2.1 acres; Low Density Zone.

APPLICANT / PRESENTATION: Ray Preece was present.

TOWN STAFF / ENGINEERING REPORT: Mr. Blake indicated the Town Engineer, David Capacchione, previously submitted his staff report for this project and had some concerns. Those concerns were provided to the applicant just very recently. The Applicants Engineer, Paul Terwilliger, addressed those comments and submitted plans today addressing all concerns.

IWWC COMMENTS: Mr. Galton was concerned that in reference to the lay of the property and amount of adequate acreage to construct the home, the applicant should not be proposing 150 feet of wetlands disturbance as this could be avoided. Mrs. Lamiotte feels Town Staff did not have adequate time to review modified plans as they were just submitted this afternoon.

MOTION #4 (04.06.20): made by Vice Chairman Galton **SECONDED BY** Ms. Dubofsky-Porter that the Inland Wetland and Watercourses approve Application #20-1485, Raymond Preece, with the following condition:

1. The applicant work with the Town Engineer, Mr. David Capacchione, & the Wetlands Agent, Jonathan Blake to meet all requirements and to minimize wetlands disturbance as much as possible.

VOICE VOTE: UNANIMOUS;

MOTION CARRIED

VII. Correspondence to the Commission:

- a. **Application #20-1487 Estate of Judith Jackson, for Notification of Timber Harvest;** Located at 115 Lake Road; GIS Map 83; Lot 1; 50 acres; Rural Development Zone.

TOWN STAFF REPORT: Mr. Blake noted this application is for correspondence only. A renewal application is required every three years by the State of CT. **NO ACTION REQUIRED.**

- b. **Application #20-1489 of NTE Connecticut LLC for Standard DEEP Notification of Tentative Decision.** Located at 189 Lake Road; GIS Map 83; Lot 6; 62 acres; Rural Development Zone. **NO ACTION REQUIRED.**

VIII. Staff Report:

- a. Authorized Agent Approval:

1. **Application #20-1488** Replace field at KHS with artificial turf. Mr. Blake noted Town Staff, the Board of Education, and Superintendent of Schools has completed a comprehensive review of this proposed project. A file has been developed by Town Staff containing plans, specifications, and information.

2. Monthly Zoning/Wetland Report: N/A

IX. Town Council Liaison: Ernest Lee, Town Council Liaison, provided an overview of recent Town activities.

X. Adjournment

MOTION #5 (04.06.20): made by Mr. Galton **SECONDED BY** Ms. Dubofsky-Porter that the Inland Wetland and Watercourses Commission adjourn at 7:50 p.m.

VOICE VOTE: UNANIMOUS;

MOTION CARRIED

Respectfully submitted, *Sherry Pollard*,
IWWC Recording Secretary

Killingly Engineering Associates

Civil Engineering & Surveying

P.O. Box 421 Killingly, CT 06241

Phone: 860-779-7299

www.killinglyengineering.com



April 6, 2020

Mr. David Capaccione, P.E.
Town of Killingly Department of Engineering
Killingly Town Hall
172 Main Street
Killingly, CT 06239

**RE: Proposed 30-Lot Subdivision
Hartford Pike (Route 101)**

Dear Mr. Capaccione;

In response to your review comment on the aforementioned project Dated February 27, 2020, we offer the following:

1. Pre and post development drainage computations are enclosed herein for your review;
2. The existing CL&P Easement is contiguous to the previously approved development at the end of Cardinal Drive. For that project, CL&P required a 10ø separation from all structures from that easement which we have maintained for this project.
3. The initial review of the project by CTDOT did not take issue with the 5% grade proposed for the site entrance. We respectfully request that the Town of Killingly consider the same;
4. The sidewalk detail has been modified accordingly to show a broom finish;
5. Traffic signs and pavement markings have been added at the site entrance per CTDOT review and locations of speed limit signs have been shown on the plans;
6. Plans have been submitted to the fire marshal for review as requested;
7. Grading has been modified at the site entrance to alleviate some of the excessive grading shown previously. In general, slopes do not begin until approximately 15ø off the traveled way.
8. Gravel maintenance access has been shown to the stormwater basin.
9. We concur that the construction access and permanent roadway entrance will require CTDOT approval. We have submitted plans to the CTDOT and received review comments which we have addressed and resubmitted to the CTDOT;
10. Air testing of sewer lines shall be conducted as required and it is noted on the cover sheet of the plans;
11. We concur that bonding for the project will be required and a bond estimate for public improvements and E&S controls is included with this submission. We note on the cover sheet that no work shall commence until the bond has been posted;
12. We acknowledge that all materials shall be approved prior to installation and that sieve, proctor and compaction testing will be required. This is noted on the cover sheet of the plans;
13. The requirement of a \$700.00 connection fee for each sanitary sewer connection has been noted on the cover sheet of the plans;
14. As required, the sewer department will be contacted prior to any proposed sanitary sewer connections. We acknowledge that any connections made and backfilled may be required to be re-exposed for Town inspection;
15. Pedestrian safety is addressed by installation of sidewalks. The project proposes to complete construction of the roadway prior to constructing any homes which will alleviate potential pedestrian conflicts;


16. A registration under the CTDEEP General Permit for the Discharge of Stormwater Associated with Construction Activities will be completed and submitted to CTDEEP upon receipt local approvals and 90 days prior to construction;
17. CTDOT has reviewed the plans and forwarded comments. Killingly Engineering addressed those comments and resubmitted plans back to the CTDOT for final approval;
18. We have enclosed a spec sheet for the typical residential grinder pump that could be utilized for this application. The final selection will be determined by the contractor or distributor;
19. It is our understanding that the long-term maintenance of the low-pressure sanitary sewer system is not something that the Town of Killingly is interested in assuming. We will propose to create a homeowner's association to maintain the system;
20. The force main is installed with backflow prevention at each connection point. It is highly unlikely that there would be simultaneous failure at multiple points to the extent where sewerage would drain back to the manhole;
21. The sediment forebay of the basin is in an area comprised of sand and gravel and will remain dry. The second bay of the basin is anticipated to have approximately 10% of water in it seasonally as it will be excavated 10' below the adjacent wetland level. Test hole results excavated in the area have been added to the plans.
22. Detail sheet has been modified to show a single type of silt fence;
23. The inclusion of a hydrant on the previous plans was erroneous and it has been removed from the plans;
24. Each house will have an individual drilled well and there is no need for a water connection detail as shown previously. It has been removed from the plans;
25. It is noted that underdrains may need to be installed if groundwater is encountered during construction;
26. As-build drawings will be provided in hard copy and AutoCAD upon completion of the project;
27. The pipe schedule sheet has been completed;
28. Riprap Swales can be re-evaluated. We would like to discuss options with the Town at their convenience.
29. Double catch basins are proposed at each side of the road at the site entrance. We do not anticipate significant water entering Route 101 and the CTDOT did not express any concerns.

We trust that the plans as modified address the February 27th review comments. Please feel free to contact us if there are any further questions or concerns.

Sincerely;





Normand Thibeault, Jr

Normand Thibeault, Jr., P.E.

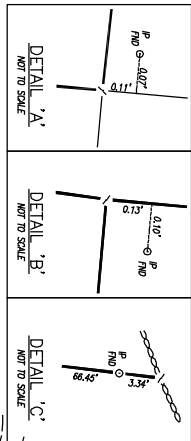

LINE DATA

L1	N	83°13'16"	W	69.37'
L2	S	73°17'40"	E	31.97'
L3	S	19°00'31"	W	38.43'
L4	S	02°24'02"	W	36.40'
L5	S	14°10'36"	W	36.40'
L6	S	85°18'15"	W	30.24'
L7	S	85°18'15"	W	30.24'

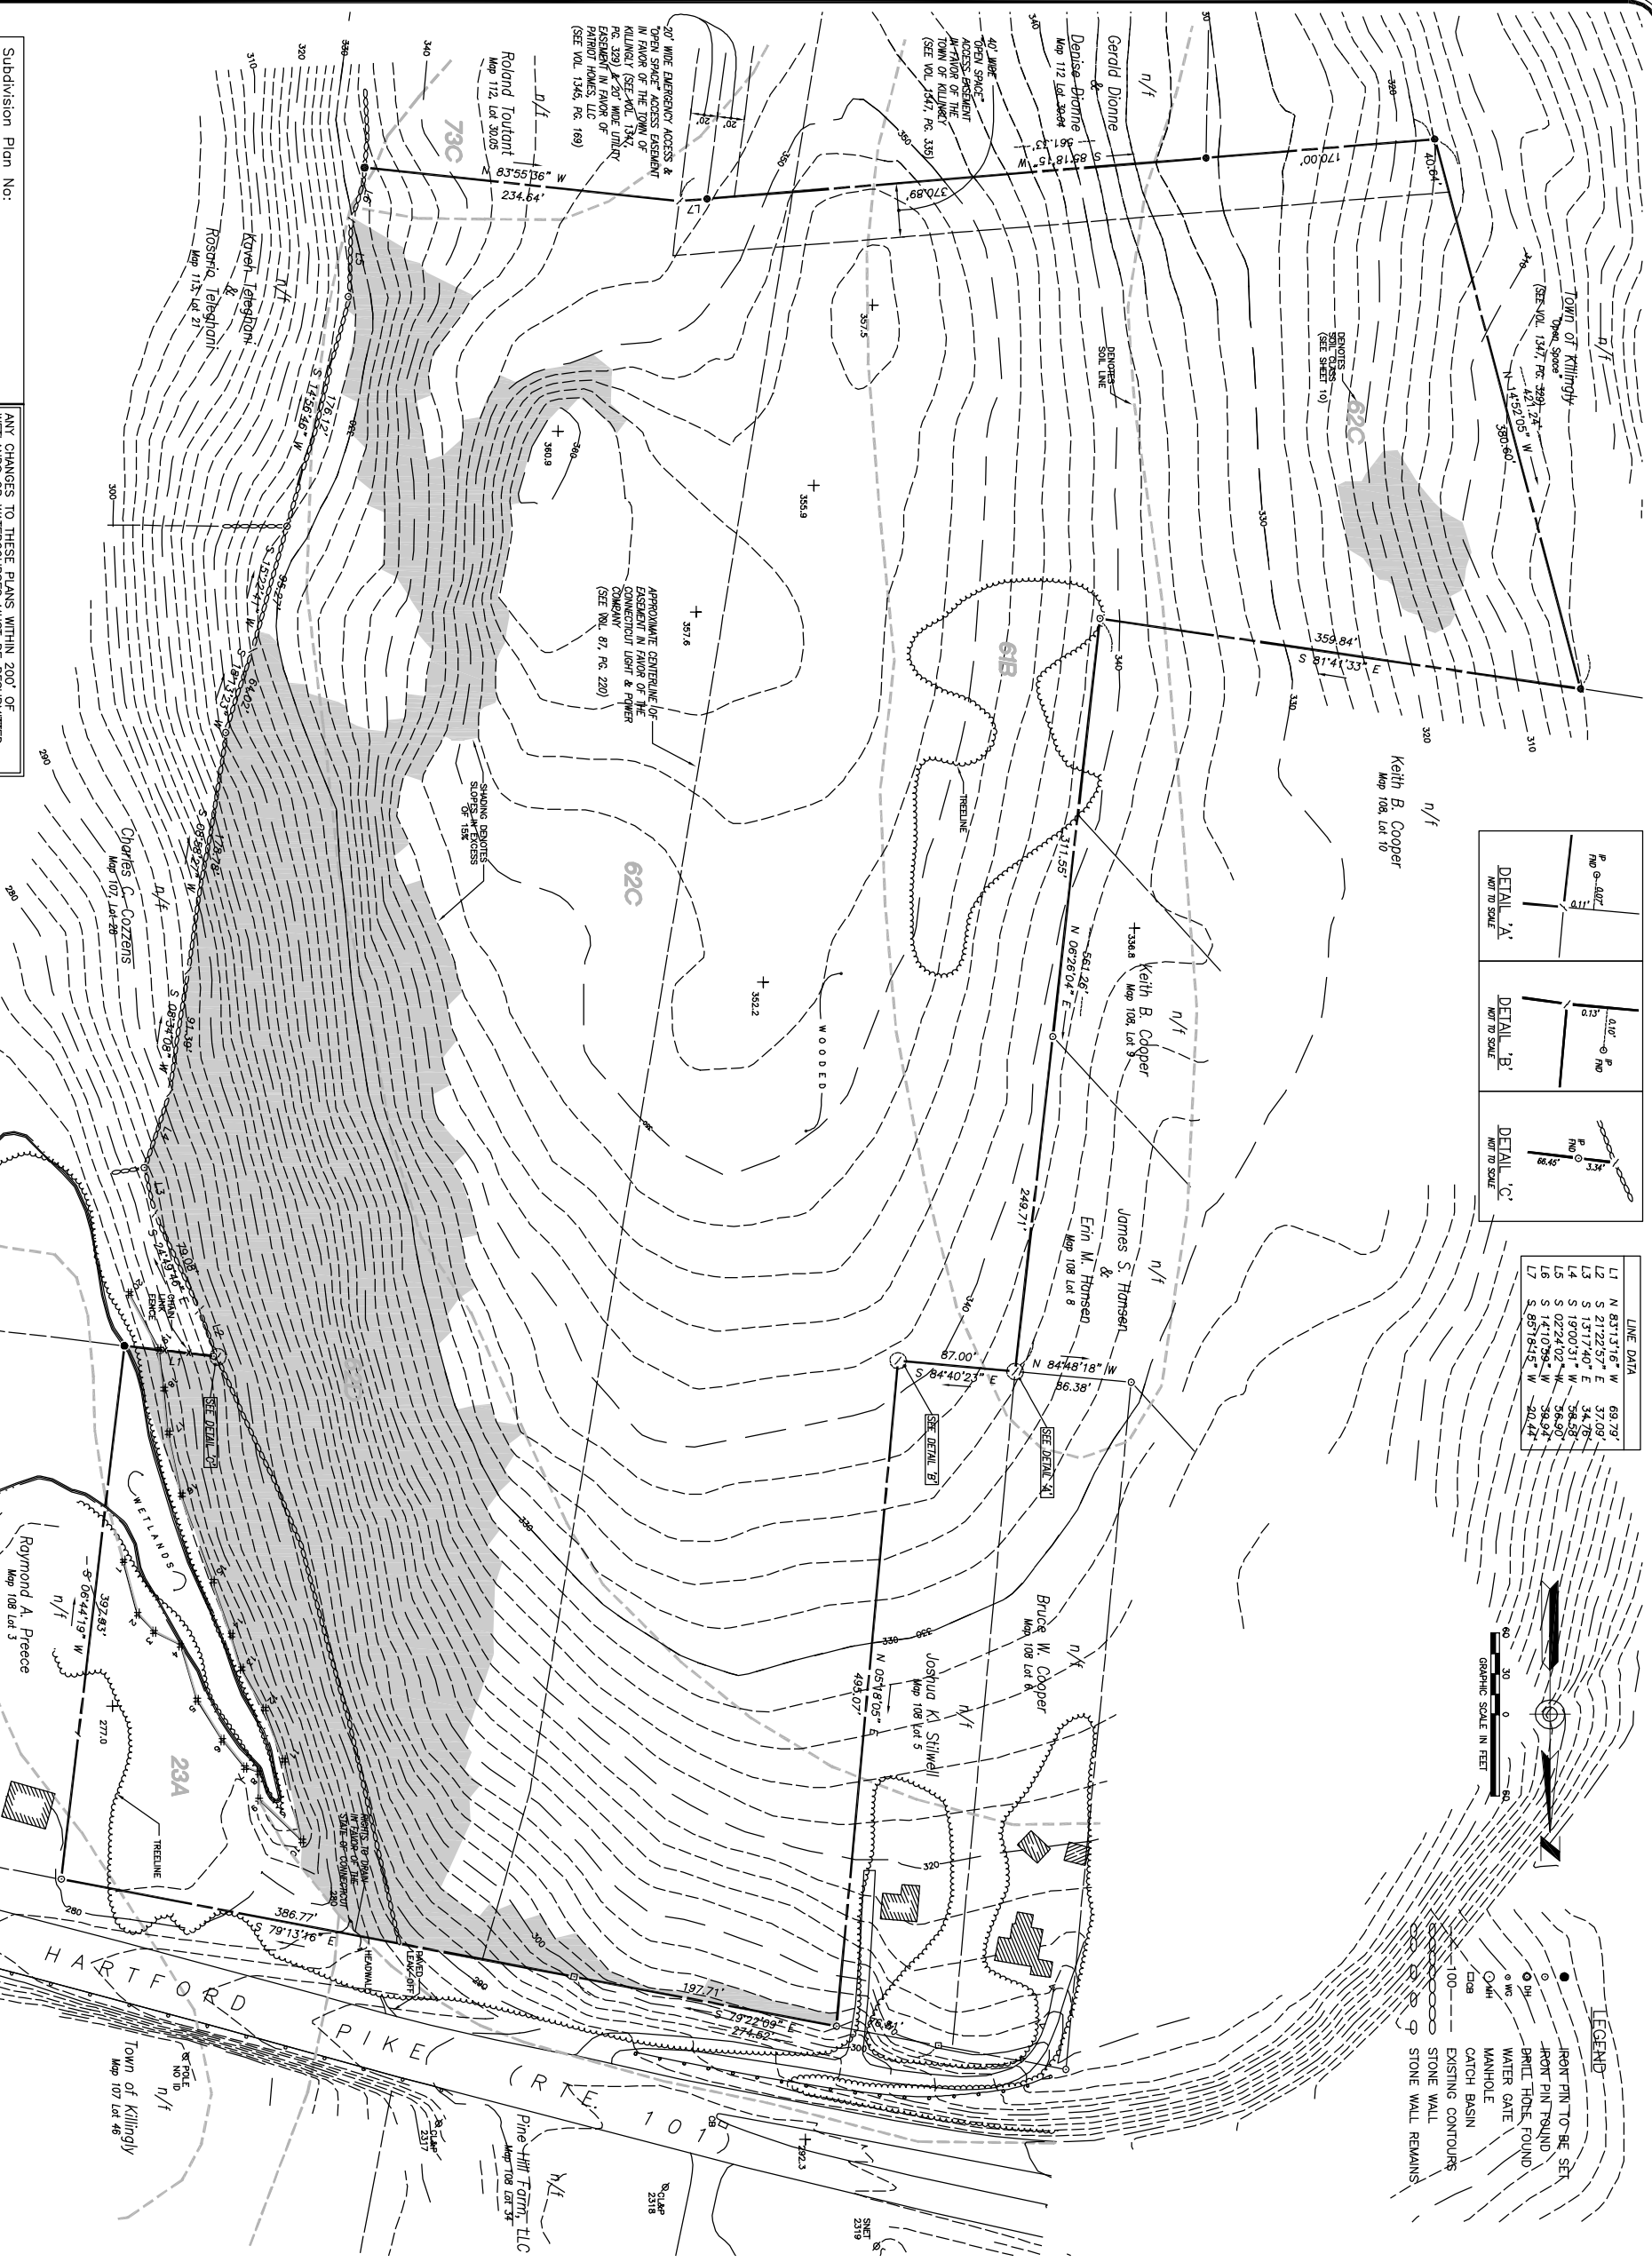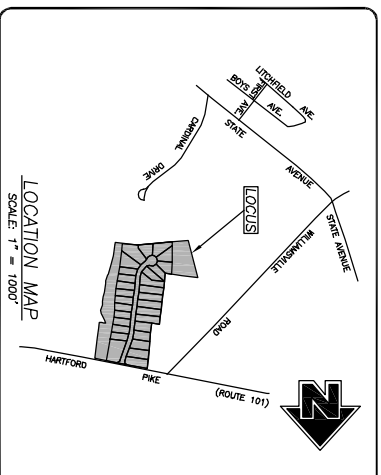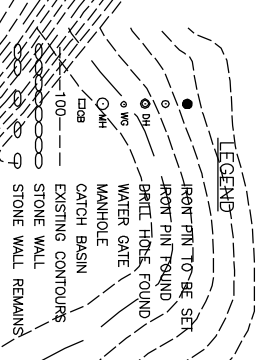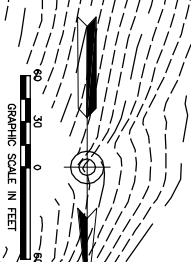

- This survey was prepared pursuant to the requirements of the Connecticut General Statutes, Chapter 200, and the Standards for Surveys and Maps in the State of Connecticut as adopted by the Connecticut Association of Land Surveyors, Inc. on September 26, 1986.
 - This survey conforms to a Class "A-2" horizontal accuracy.
 - Survey Type: Property Survey.
 - Boundary Determination Category: Dependent Resurvey.
 - Topographic features conform to a Class "A-2", "A-2" vertical accuracy.
- Zone = LD.
- Owner of record: Patriot Homes, LLC
189 Watch Hill Drive
Westley, RI 01891
See Vol. 1046, Pg. 215
- Parcel is shown as Lot #4 on Assessors Map #108.
- Elevations shown are based on an North American Vertical Datum of 1988. Orthometric elevations taken from the Town of Killington GIS data. Contour Interval = 2'.
- Parcel lies within Flood Hazard Zone "C" (areas of minimal flooding) as shown on FRM Map #090136 Panel 0004B Effective Date: January 3, 1983.
- Wetlands shown were flagged in the field by Precast Environmental Services, LLC and are taken from map reference #1.

- MAP REFERENCE:
- Subdivision Map No. 1 & Subdivision Map No. 2 - Prepared for Connecticut Home Builders Hartford Pike (Route 101) & Cordinal Drive - Revised to: 10/26/2006 - Sheets 2 of 23 & 3 of 23 - Prepared by: Provost & Rovero, Inc." Not on file.
 - Property Survey - Showing Boundary, Line Adjustment and Plat of Property of - Jill Marguard - Hartford Pike (Route 101) & Cordinal Drive - Revised to: 11/29/2017 - Sheet 1 of 1 - Prepared by: Killington Engineering Associates, Inc. On file in the Town of Killington Land Records as Map #8385.
 - Subdivision Map - Prepared for - Jill Marguard, Trustee Cordinal Drive - Killington, Connecticut - Scale: 1" = 60' - Date: 1/1/2004 - Prepared by: Killington Engineering Associates - On file in the Town of Killington Land Records as Map #7070.

DATE	REVISIONS	DESCRIPTION
4/06/2020	PER ENGINEERING REVIEW	
3/12/2020	CITIZEN COMMENTS	
2/20/2020	FINAL PLAN REVIEW	

PROPERTY SURVEY
SHOWING EXISTING CONDITIONS
PREPARED FOR
PATRIOT HOMES, LLC
HARTFORD PIKE (ROUTE 101)
KILLINGTON, CONNECTICUT

Subdivision Plan No: _____
APPROVED BY THE TOWN OF
KILLINGTON PLANNING AND ZONING COMMISSION
CHAIRMAN _____ DATE _____
Expiration date per Sec. 8-26c, Conn. Gen. Statutes: _____

Subdivision Plan No: _____
APPROVED BY THE TOWN OF
KILLINGTON INLAND WETLANDS COMMISSION
CHAIRMAN _____ DATE _____

TO MY KNOWLEDGE AND BELIEF, THIS MAP IS SUBSTANTIALLY CORRECT
AS NOTED HEREON,
GREG A. GLAUDE, L.S. U.C. NO. 70191 DATE _____
NO CERTIFICATION IS EXPRESSED OR IMPLIED UNLESS THIS MAP BEARS
THE ORIGINAL SEAL AND SIGNATURE OF THE LAND SURVEYOR.

DATE:	1/15/2020	DRAWN:	AAR
SCALE:	1" = 60'	DESIGN:	NET
SHEET:	2 OF 14	CHK. BY:	GG
DWG. NO. CLIENT FILE:		JOB NO.:	16130

APPROVED BY THE TOWN OF KILLINGLY PLANNING AND ZONING COMMISSION

CHAIRMAN _____ DATE _____

Expiration date per Sec. 8-26c, Conn. Gen. Statutes: _____

APPROVED BY THE TOWN OF KILLINGLY INLAND WETLANDS COMMISSION

CHAIRMAN _____ DATE _____

Subdivision Plan No: _____

ANY CHANGES TO THESE PLANS WITHIN 200' OF WETLANDS OR WATERCOURSES MUST BE RESUBMITTED TO THE KILLINGLY INLAND WETLANDS AND WATERCOURSES COMMISSION FOR ITS APPROVAL.

THE APPLICANT WILL CONTRACT THE KILLINGLY INLAND WETLANDS AND WATERCOURSES COMMISSION'S AGENT TO CONDUCT A FIELD SURVEY TO VERIFY CONSTRUCTION OR EXCAVATION ON THE PROPERTY.

THE APPLICANT WILL CONTRACT THE KILLINGLY INLAND WETLANDS AND WATERCOURSES COMMISSION'S AGENT TO CONDUCT A FIELD SURVEY TO VERIFY CONSTRUCTION OR EXCAVATION ON THE PROPERTY.

TO MY KNOWLEDGE AND BELIEF, THIS MAP IS SUBSTANTIALLY CORRECT AS NOTED HEREON.

GREG A. GLAUDE, L.S. U.C. NO. 70191 DATE _____

NO CERTIFICATION IS EXPRESSED OR IMPLIED UNLESS THIS MAP BEARS THE ORIGINAL SEAL AND SIGNATURE OF THE LAND SURVEYOR.

TO MY KNOWLEDGE AND BELIEF, THIS MAP IS SUBSTANTIALLY CORRECT AS NOTED HEREON.

GREG A. GLAUDE, L.S. U.C. NO. 70191 DATE _____

NO CERTIFICATION IS EXPRESSED OR IMPLIED UNLESS THIS MAP BEARS THE ORIGINAL SEAL AND SIGNATURE OF THE LAND SURVEYOR.

Killingly Engineering & Surveying
Civil Engineering & Surveying

111 Wilson Blvd
Killingly, Connecticut 06241
Phone: (860) 739-7299
www.killinglyengineering.com



Patriot Homes, LLC
HARTFORD PIKE (ROUTE 101)
KILLINGLY, CONNECTICUT

PREPARED FOR
Patriot Homes, LLC

SUBDIVISION MAP

DATE: 1/15/2020
SCALE: 1" = 60'
SHEET: 3 OF 14
DWG. NO: CLIENT FILE

DRAWN: AMR
DESIGN: NET
CHK. BY: GS
JOB NO: 16130

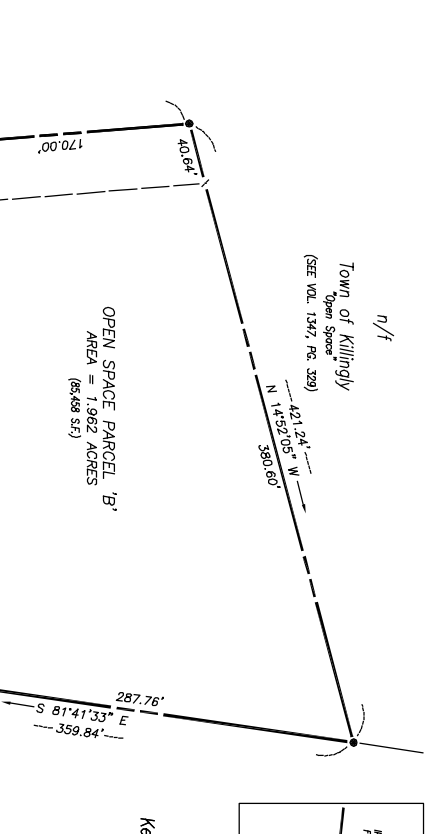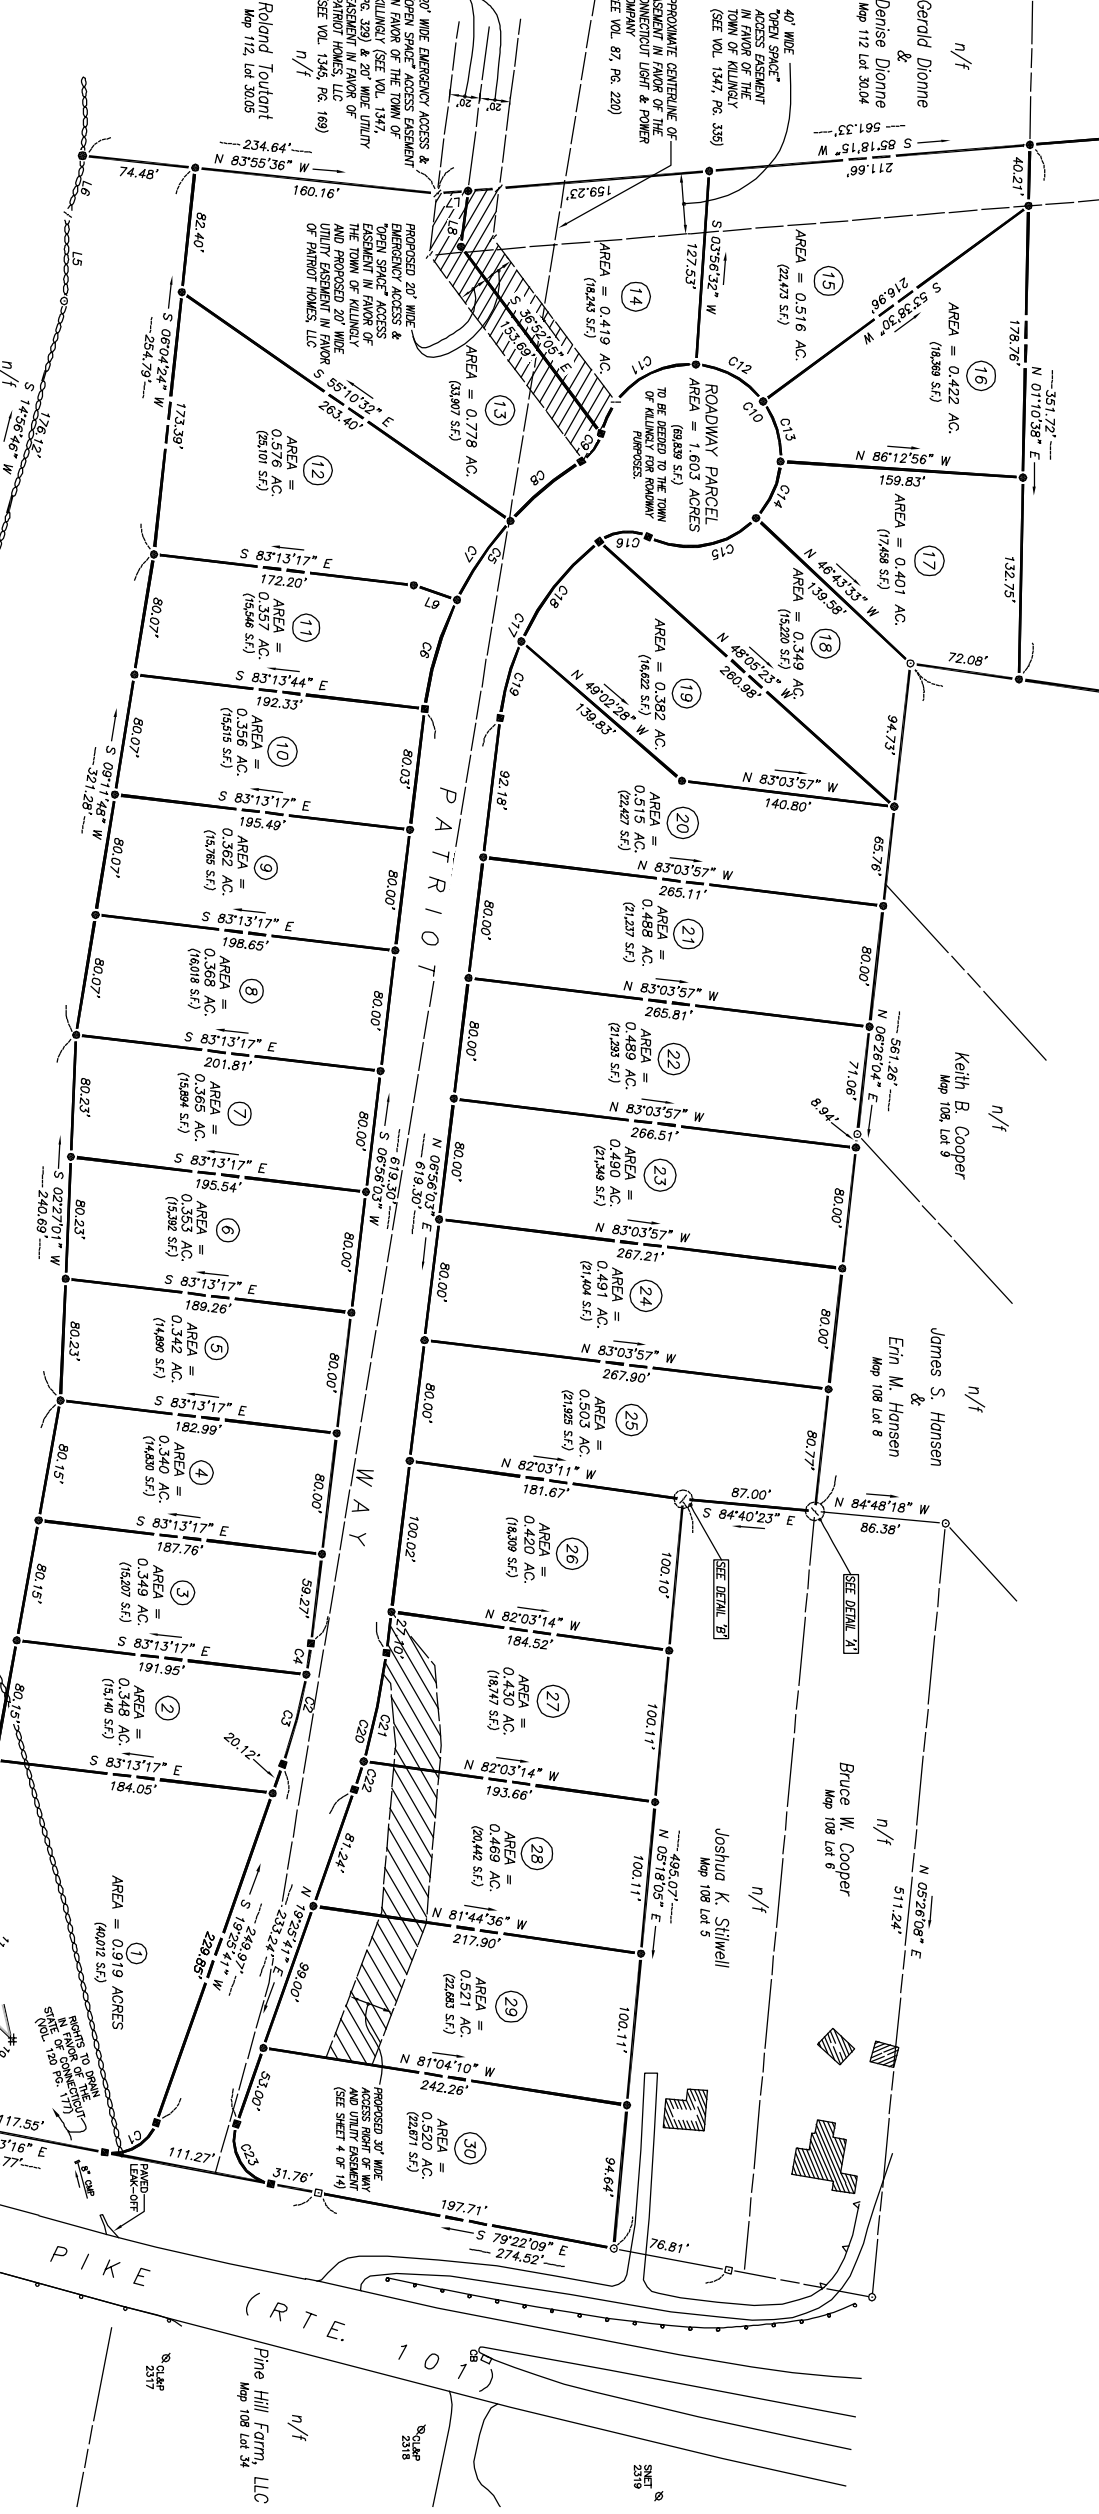

LINE DATA

L1	N 83°13'17" W	69.30'
L2	S 1°17'40" E	34.78'
L3	S 1°17'40" E	34.78'
L4	S 1°17'40" E	34.78'
L5	S 1°17'40" E	34.78'
L6	S 1°17'40" E	34.78'
L7	S 1°17'40" E	34.78'
L8	S 1°17'40" E	34.78'
L9	S 1°17'40" E	34.78'

CURVE DATA

C1	R = 30.00'	D = 172.93°	L = 42.80'
C2	R = 30.00'	D = 172.93°	L = 42.80'
C3	R = 30.00'	D = 172.93°	L = 42.80'
C4	R = 30.00'	D = 172.93°	L = 42.80'
C5	R = 30.00'	D = 172.93°	L = 42.80'
C6	R = 30.00'	D = 172.93°	L = 42.80'
C7	R = 30.00'	D = 172.93°	L = 42.80'
C8	R = 30.00'	D = 172.93°	L = 42.80'
C9	R = 30.00'	D = 172.93°	L = 42.80'
C10	R = 30.00'	D = 172.93°	L = 42.80'
C11	R = 30.00'	D = 172.93°	L = 42.80'
C12	R = 30.00'	D = 172.93°	L = 42.80'
C13	R = 30.00'	D = 172.93°	L = 42.80'
C14	R = 30.00'	D = 172.93°	L = 42.80'
C15	R = 30.00'	D = 172.93°	L = 42.80'
C16	R = 30.00'	D = 172.93°	L = 42.80'
C17	R = 30.00'	D = 172.93°	L = 42.80'
C18	R = 30.00'	D = 172.93°	L = 42.80'
C19	R = 30.00'	D = 172.93°	L = 42.80'
C20	R = 30.00'	D = 172.93°	L = 42.80'
C21	R = 30.00'	D = 172.93°	L = 42.80'
C22	R = 30.00'	D = 172.93°	L = 42.80'
C23	R = 30.00'	D = 172.93°	L = 42.80'
C24	R = 30.00'	D = 172.93°	L = 42.80'
C25	R = 30.00'	D = 172.93°	L = 42.80'
C26	R = 30.00'	D = 172.93°	L = 42.80'
C27	R = 30.00'	D = 172.93°	L = 42.80'
C28	R = 30.00'	D = 172.93°	L = 42.80'
C29	R = 30.00'	D = 172.93°	L = 42.80'
C30	R = 30.00'	D = 172.93°	L = 42.80'

NOTES:



- This survey has been prepared pursuant to the Regulations of the State of Connecticut, Department of Environmental Services, as adopted by the Connecticut Association of Land Surveyors, Inc. on September 26, 1986.
- This survey conforms to a Class "A-2" horizontal accuracy.
- Survey Type: Subdivision Map.
- Boundary Determination Category: Independent Recovery, Along Proposed Property Lines: Original Survey.
- Total area of subdivision = 20,761 Acres.
- Zone = LD.
- Owner of record: Patriot Homes, LLC
188 Watch Hill Drive
Seymour, CT 06488
See Vol. 1046, Pg. 215
- Parcel is shown as Lot #4 on Assessors Map #108.
- Elevations shown are based on an North American Vertical Datum of 1988 (NAVD 88). Contours taken from the Town of Killingly's GIS data. Contour Interval = 2'.
- Parcel lies within Flood Hazard Zone "C" (Areas of minimal flood hazard). Flood Hazard Zone "C" is defined by the Flood Insurance Rate Map #390158-FIRM (00048) Effective Date January 3, 1985.
- Wetlands shown were flagged in the field by Pinecrest Environmental Services, LLC and are taken from map reference #1.

MAP REFERENCE:

- Subdivision Map No. 1 & Subdivision Map No. 2 - Prepared for Connecticut Home Builders Hartford Pike (Route 101) & Central Drive - Killingly, Connecticut - Scale: 1" = 60' - Date: 10/17/2004 - Revised to: 10/28/2006 - Sheets 2 of 23 & 3 of 23 - Prepared by: Provost & Rovero, Inc.* Not on file.
- Property Survey - Showing Boundary, Line Adjustment and P.L.C. and Property of - Jill Morquardt - Hartford Pike (Route 101) & Central Drive - Killingly, Connecticut - Scale: 1" = 60' - Date: 11/02/2017 - Revised for: 11/29/2017 - Sheet: 1 of 1 - Prepared by: Killingly Engineering & Surveying. On file in the Town of Killingly Land Records as Map #16855.
- Subdivision Map - Prepared for - Jill Morquardt, Trustee of Conard Dye - Killingly, Connecticut - Scale: 1" = 60' - Date: 1/1/2004 - Prepared by: Killingly Engineering Associates.* On file in the Town of Killingly Land Records as Map #7070.


REVISIONS

DATE	DESCRIPTION
4/06/2020	PER ENGINEERING REVIEW
3/12/2020	COLOR COMMENTS
2/20/2020	FINAL PLAN REVIEW

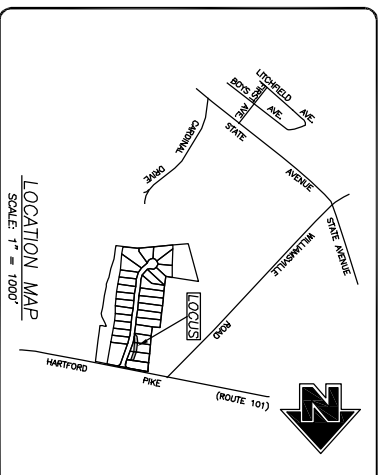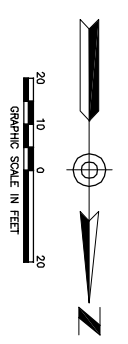

LINE DATA
L10 S 38°44'59" E 7.37'

CURVE DATA			
C2 (Total)	R = 375.00'	C3	R = 375.00'
D = 1229.57'	L = 1229.57'	D = 1229.57'	L = 1229.57'
CH = S 131°0'52" W	81.77'	CH = S 131°0'52" W	81.77'
C20 (Total)	R = 425.00'	C21 (Lot Total)	R = 425.00'
D = 1229.58'	L = 1229.58'	D = 1229.58'	L = 1229.58'
CH = S 131°0'52" W	81.67'	CH = S 131°0'52" W	81.67'
C24	R = 30.00'	C25	R = 425.00'
D = 98.5857'	L = 157.59'	D = 157.59'	L = 157.59'
CH = S 29°53'48" E	14.58'	CH = S 07°55'02" W	58.53'

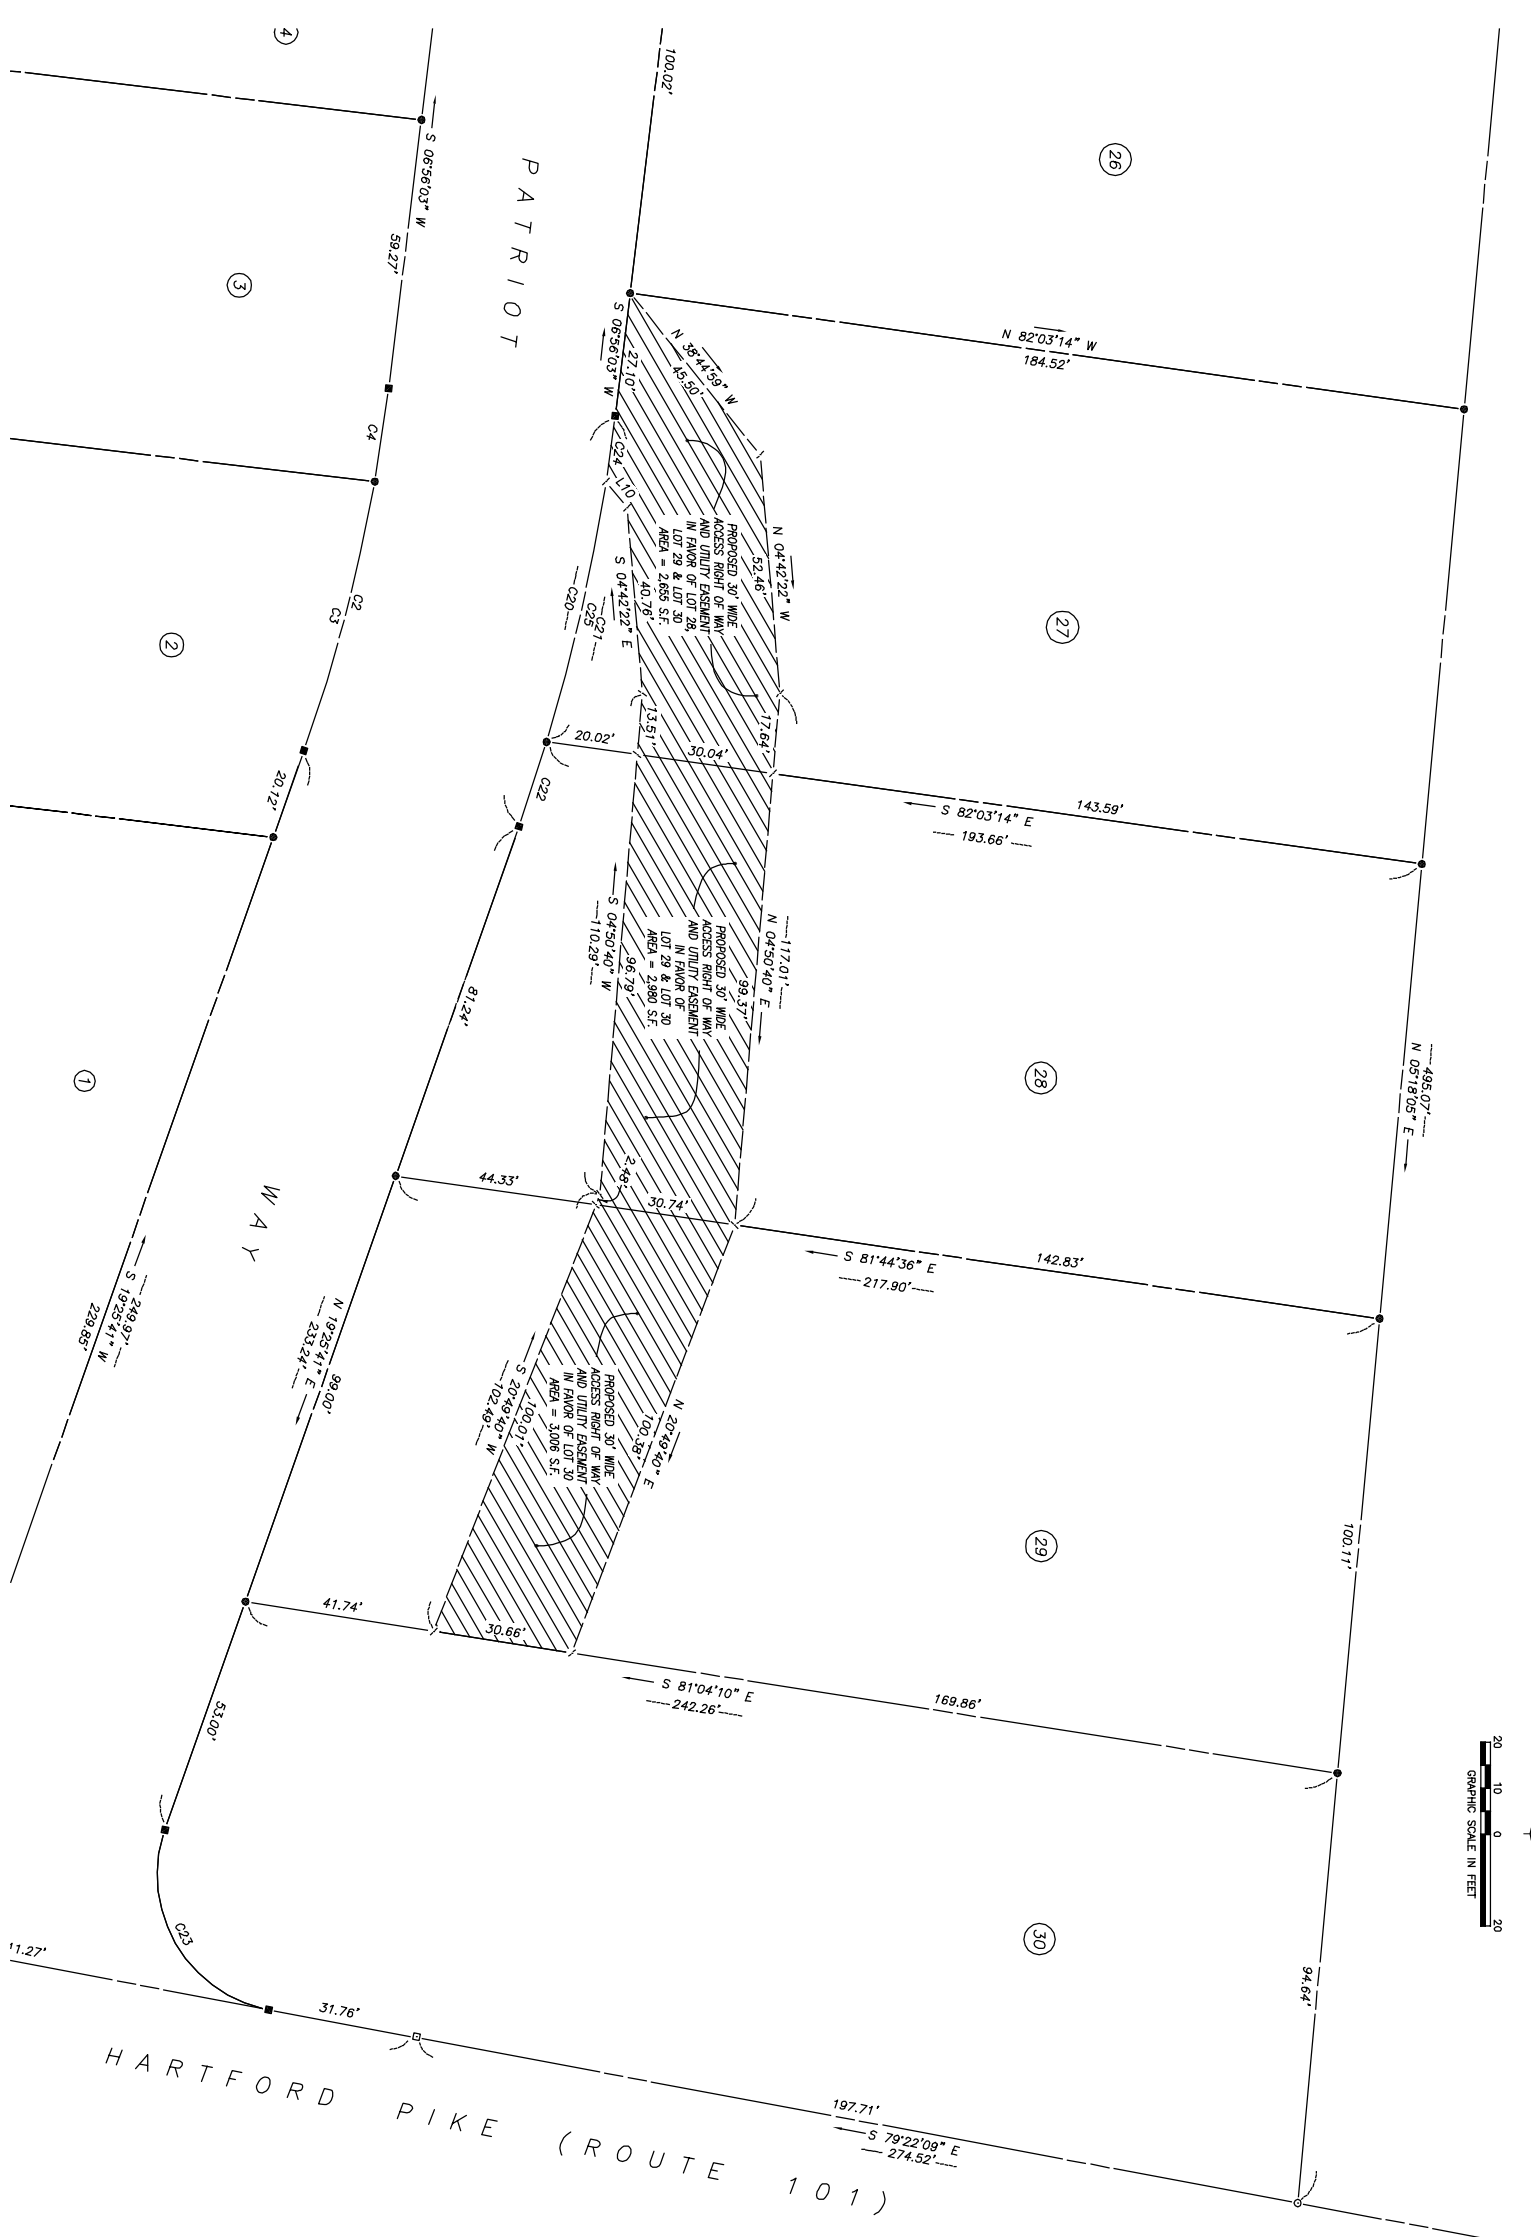

NOTES:

- This survey has been prepared pursuant to the Regulations of the State of Connecticut, and the Standards for Surveyors and Maps in the State of Connecticut, as adopted by the Connecticut Association of Land Surveyors, Inc. on September 26, 1996;
 - This survey conforms to a Class "A"-2 horizontal accuracy;
 - Survey Type: Easement Map.
- Owner of record: Patriot Homes, LLC
180 Hartford Pike, Suite 100
Westerly, RI 01891
See Vol. 1046, Pg. 215

DATE	DESCRIPTION	REVISIONS
4/06/2020	PER ENGINEERING REVIEW	
3/12/2020	CITIZEN COMMENTS	
2/20/2020	FINAL PLAN REVIEW	
DATE	DESCRIPTION	REVISIONS

EASEMENT MAP
PREPARED FOR
PATRIOT HOMES, LLC
HARTFORD PIKE (ROUTE 101)
KILLINGLY, CONNECTICUT

Killingly Engineering Associates
Civil Engineering & Surveying
111 Western Blvd.
P.O. Box 43
Killingly, Connecticut 06241
(860) 798-7299
www.killinglyengineering.com

DATE: 1/15/2020
SCALE: 1" = 20'
SHEET: 4 OF 14
DWG. NO: CLIENT FILE

Subdivision Plan No: _____
APPROVED BY THE TOWN OF KILLINGLY PLANNING AND ZONING COMMISSION
CHAIRMAN _____ DATE _____
Expiration date per Sec. 8-28a, Conn. Gen. Statutes: _____

ANY CHANGES TO THESE PLANS WITHIN 200' OF WETLANDS OR WATERCOURSES MUST BE RESUBMITTED TO THE KILLINGLY INLAND WETLANDS AND WATERCOURSES COMMISSION FOR ITS APPROVAL.
THE APPLICANT WILL CONTRACT THE KILLINGLY INLAND WETLANDS AND WATERCOURSES COMMISSION'S AGENT FOR AN IN-PLACE AND IN-PLACE CONSTRUCTION OR EXCAVATION ON THE PROPERTY.

APPROVED BY THE TOWN OF KILLINGLY INLAND WETLANDS COMMISSION
CHAIRMAN _____ DATE _____

LEGEND
● IRON PIN TO BE SET
○ IRON PIN FOUND

TO MY KNOWLEDGE AND BELIEF, THIS MAP IS SUBSTANTIALLY CORRECT AS NOTED HEREON,
GREG A. GLAUDE, L.S.
L.C. NO. 70191
DATE

NO CERTIFICATION IS EXPRESSED OR IMPLIED UNLESS THIS MAP BEARS THE ORIGINAL SEAL AND SIGNATURE OF THE LAND SURVEYOR.

SEE SITE DEVELOPMENT PLAN NO. 2





Subdivision Plan No: _____
 APPROVED BY THE TOWN OF KILLINGLY PLANNING AND ZONING COMMISSION
 CHAIRMAN _____ DATE _____
 Expiration date per Sec. 8-28a, Conn. Gen. Statutes: _____

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APPROVED BY THE TOWN OF KILLINGLY INLAND WETLANDS COMMISSION
 CHAIRMAN _____ DATE _____



**BEFORE YOU DIG
 CALL BEFORE YOU DIG**
 AT LEAST TWO BUSINESS DAYS BEFORE DIGGING OR DISTURBING EARTH
 DIAL 811 OR 1-800-922-4455

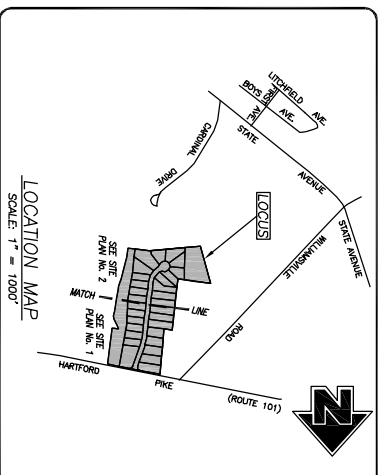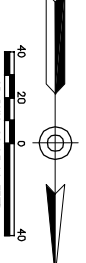

CURVE DATA

C1	R = 30.00'	L = 42.80'
C2 (Total)	R = 375.00'	L = 81.77'
C3	R = 375.00'	L = 20.74'
C4	R = 225.00'	L = 75.19'
C5 (Total)	R = 30.00'	L = 83.83'
C6	R = 60.00'	L = 52.01'
C7	R = 225.00'	L = 22.94'
C8	R = 30.00'	L = 83.83'
C9	R = 60.00'	L = 175.00'
C10 (Total)	R = 30.00'	L = 136.65'
C11	R = 60.00'	L = 84.04'
C12	R = 60.00'	L = 42.07'
C13	R = 60.00'	L = 41.36'
C14	R = 60.00'	L = 77.25'
C15	R = 60.00'	L = 34.23'
C16	R = 60.00'	L = 136.65'
C17 (Total)	R = 425.00'	L = 92.67'
C18	R = 425.00'	L = 73.16'
C19	R = 175.00'	L = 52.61'
C20 (Total)	R = 425.00'	L = 19.51'
C21	R = 425.00'	L = 51.65'
C22	R = 425.00'	L = 30.00'
C23	R = 425.00'	L = 51.65'

FOR ALL STORM DRAINAGE AND SANITARY SEWER STRUCTURE SCHEDULES SEE SHEET 8.

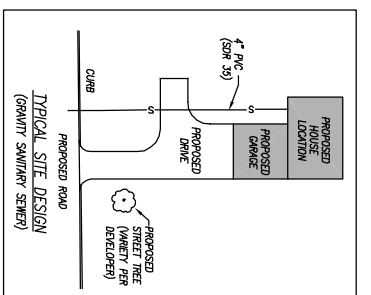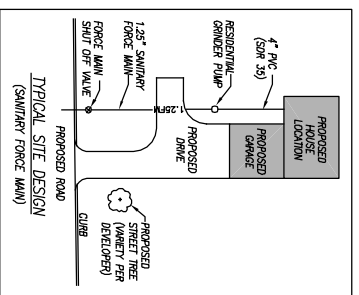

- LEGEND**
- IRON PIN TO BE SET
 - IRON PIN FOUND
 - DRILL HOLE FOUND
 - CONCRETE MONUMENT TO BE SET
 - WC
 - CB
 - SHH
 - WATER GATE
 - EXISTING CATCH BASIN
 - PROPOSED CATCH BASIN
 - EXISTING SANITARY SEWER MANHOLE
 - PROPOSED SANITARY SEWER MANHOLE
 - BUILDING SETBACK LINE
 - EXISTING CONTOURS
 - PROPOSED SANITARY SEWER LINE
 - PROPOSED UNDERGROUND UTILITIES
 - PROPOSED OVERHEAD WIRES
 - STONE WALL
 - STONE WALL REMAINS
 - SILT FENCE

REVISIONS

DATE	DESCRIPTION
4/06/2020	PER ENGINEERING REVIEW
3/12/2020	CIVIL COMMENTS
2/20/2020	FINAL PLAN REVIEW


SITE DEVELOPMENT PLAN NO. 1
 PREPARED FOR
PATRIOT HOMES, LLC
 HARTFORD PIKE (ROUTE 101)
 KILLINGLY, CONNECTICUT

Killingly Engineering Associates
 Civil Engineering & Surveying
 111 Western Blvd.
 P.O. Box 431
 Killingly, Connecticut 06241
 www.killinglyengineering.com
 (860) 795-7299

DATE: 1/15/2020
 SCALE: 1" = 40'
 SHEET: 5 OF 14
 DMC: NO. CLIENT FILE





DRAWN: AAR
 DESIGN: NET
 CHK. BY: GG
 JOB NO.: 16130

NORMAN E. THIBOUT, JR., P.E. DATE

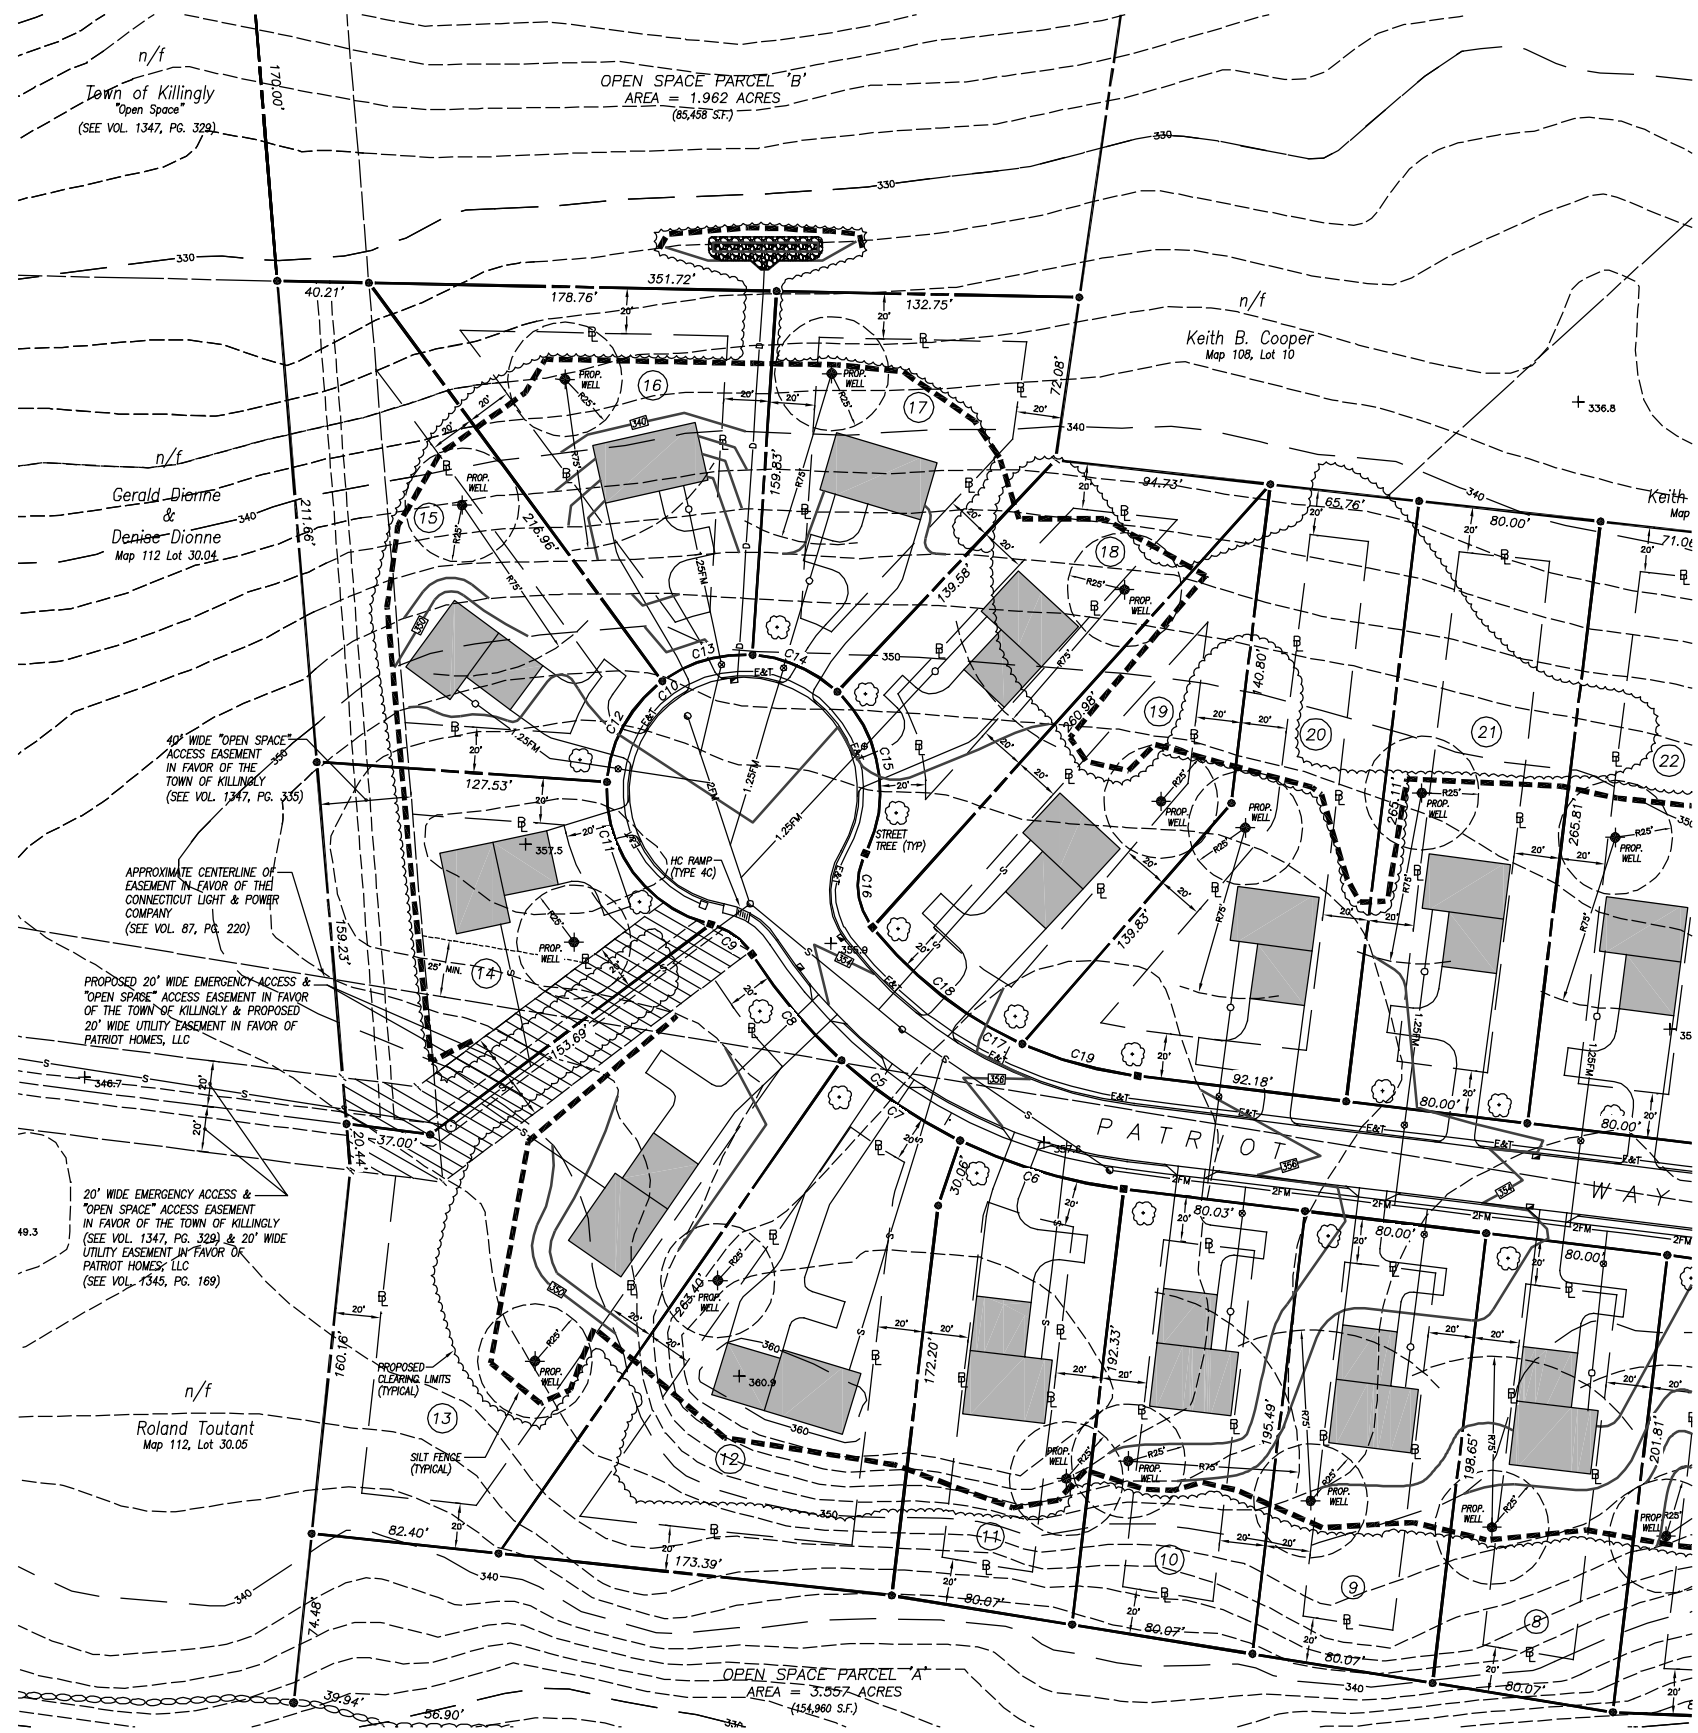

CURVE DATA

C1 R = 30.00' L = 42.60'	C2 (Total) R = 375.00' L = 81.77'	C3 R = 375.00' L = 61.03'	C4 R = 375.00' L = 20.74'	C5 (Total) R = 225.00' L = 199.24'	C6 R = 225.00' L = 75.19'
C7 R = 225.00' L = 62.95'	C8 R = 225.00' L = 61.10'	C9 R = 30.00' L = 22.94'	C10 (Total) R = 60.00' L = 296.55'	C11 R = 60.00' L = 83.83'	C12 R = 60.00' L = 52.01'
C13 R = 60.00' L = 42.07'	C14 R = 60.00' L = 41.36'	C15 R = 60.00' L = 77.25'	C16 R = 30.00' L = 34.23'	C17 (Total) R = 175.00' L = 136.65'	C18 R = 175.00' L = 84.04'
C19 R = 175.00' L = 52.61'	C20 (Total) R = 425.00' L = 92.67'	C21 R = 425.00' L = 73.16'	C22 R = 425.00' L = 19.51'	C23 R = 30.00' L = 51.65'	

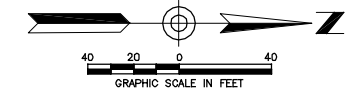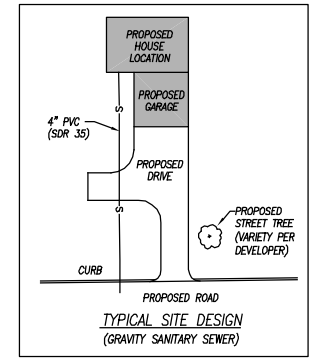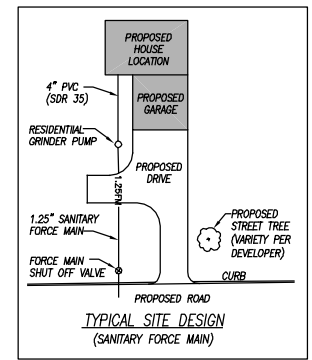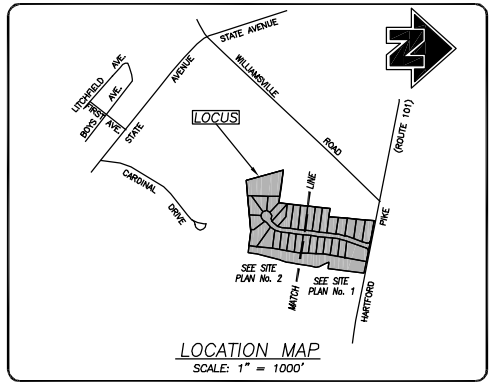

FOR ALL STORM DRAINAGE AND SANITARY SEWER STRUCTURE SCHEDULES SEE SHEET 8.

- LEGEND**
- IRON PIN TO BE SET
 - IRON PIN FOUND
 - ⊙ DH DRILL HOLE FOUND
 - CONCRETE MONUMENT TO BE SET
 - ⊙ WG WATER GATE
 - CB EXISTING CATCH BASIN
 - CB PROPOSED CATCH BASIN
 - SMH EXISTING SANITARY SEWER MANHOLE
 - ⊙ SMH PROPOSED SANITARY SEWER MANHOLE
 - BLDG SETBACK LINE
 - 100' EXISTING CONTOURS
 - 100' PROPOSED CONTOURS
 - S PROPOSED SANITARY SEWER LINE
 - EAT PROPOSED UNDERGROUND UTILITIES
 - OHW PROPOSED OVERHEAD WIRES
 - ⊖ STONE WALL
 - ⊖ STONE WALL REMAINS
 - SILT FENCE

DATE	DESCRIPTION
4/06/2020	PER ENGINEERING REVIEW
3/12/2020	CTDOT COMMENTS
2/20/2020	FINAL PLAN REVIEW
DATE	DESCRIPTION
	REVISIONS

SITE DEVELOPMENT PLAN NO. 2
PREPARED FOR
PATRIOT HOMES, LLC
HARTFORD PIKE (ROUTE 101)
KILLINGLY, CONNECTICUT

Killingly Engineering Associates
Civil Engineering & Surveying
114 Westcott Road
P.O. Box 421
Killingly, Connecticut 06241
(860) 779-7299
www.killinglyengineering.com

DATE: 1/15/2020	DRAWN: AMR
SCALE: 1" = 40'	DESIGN: NET
SHEET: 6 OF 14	CHK BY: GG
DWG. No: CLIENT FILE	JOB No: 16130

Subdivision Plan No:
APPROVED BY THE TOWN OF KILLINGLY PLANNING AND ZONING COMMISSION
CHAIRMAN DATE
Expiration date per Sec. 8.26c, Conn. Gen. Statutes:




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APPROVED BY THE TOWN OF KILLINGLY INLAND WETLANDS COMMISSION
CHAIRMAN DATE

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AT LEAST TWO FULL BUSINESS DAYS
BEFORE DIGGING OR DISTURBING EARTH
DIAL 811 OR 1-800-922-4455

NORMAND E. THIBEAULT, JR., P.E. DATE

K:\16130\Drawings\Subdivision 2020\05-08-16130 SITE PLANS.dwg Jul 01, 2020 - 7:17 AM

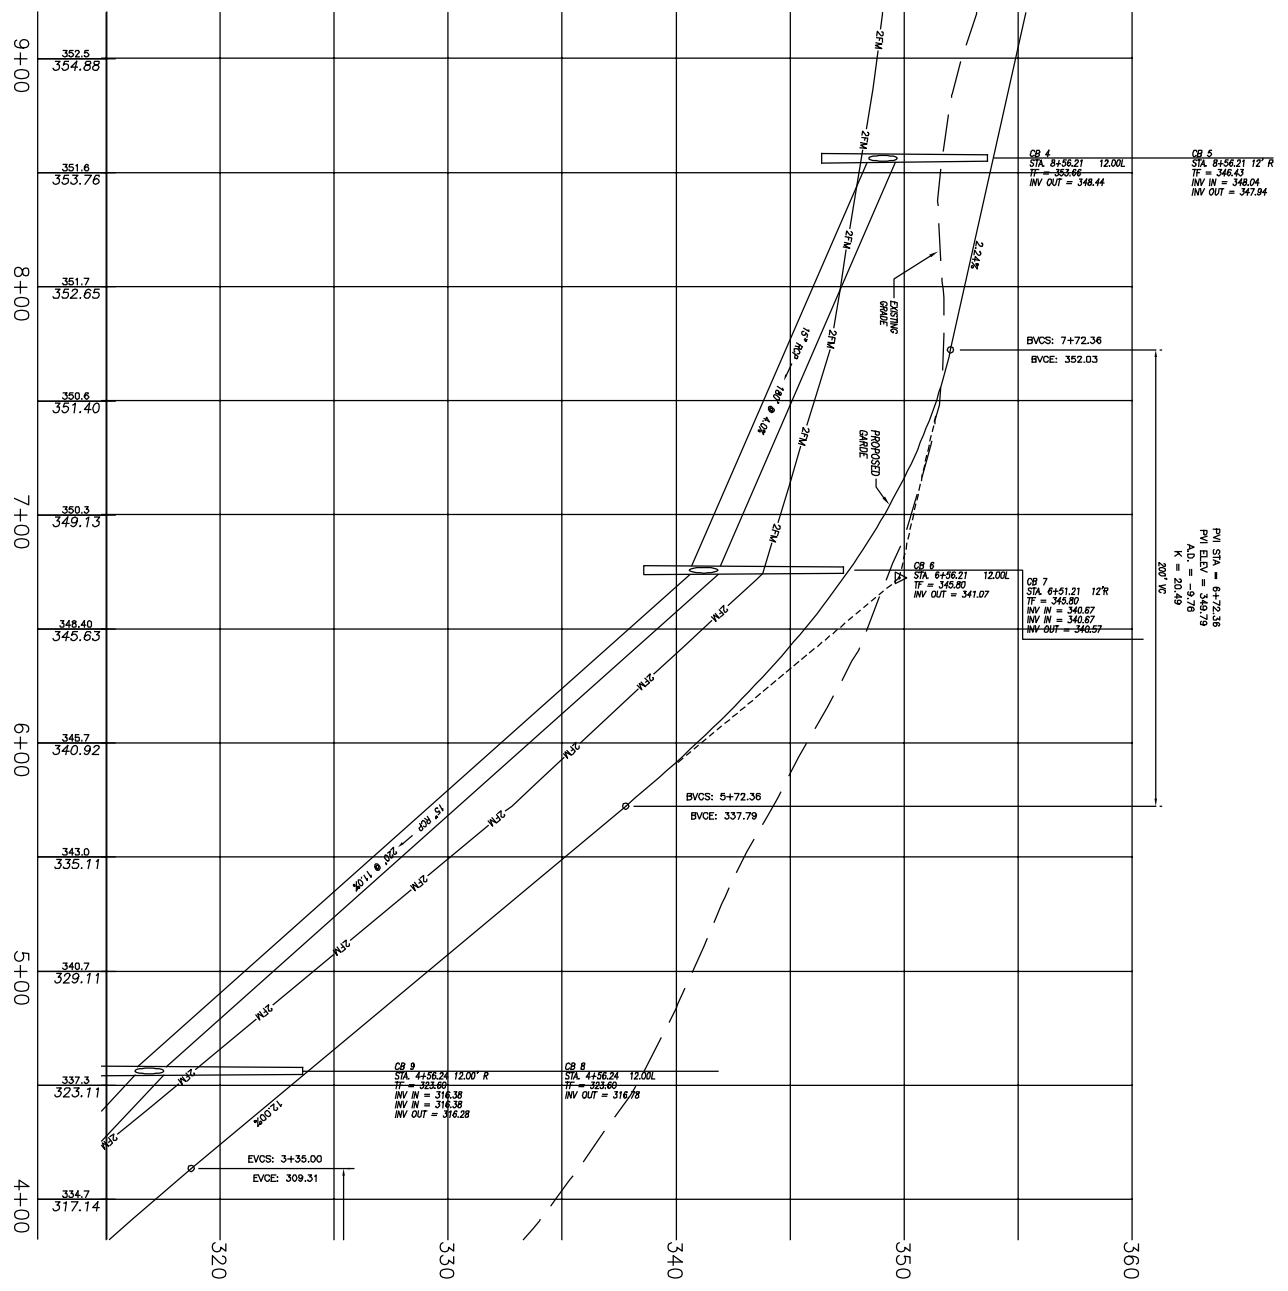
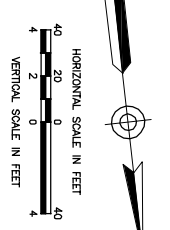
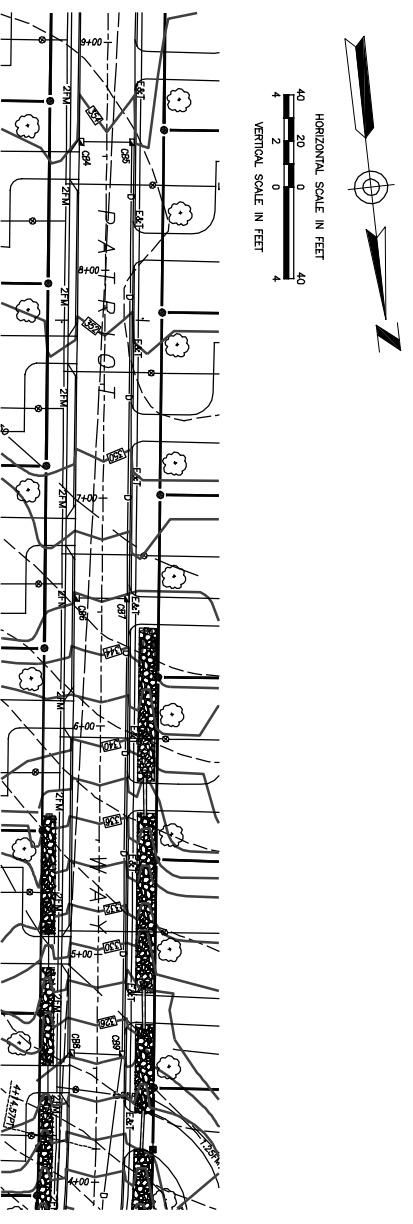


Subdivision Plan No: _____
 APPROVED BY THE TOWN OF KILLINGLY PLANNING AND ZONING COMMISSION
 CHAIRMAN _____ DATE _____
 Expiration date per Sec. 8-26a, Conn. Gen. Statutes: _____

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APPROVED BY THE TOWN OF KILLINGLY INLAND WETLANDS COMMISSION
 CHAIRMAN _____ DATE _____



Subdivision Plan No: _____
 APPROVED BY THE TOWN OF KILLINGLY PLANNING AND ZONING COMMISSION
 CHAIRMAN _____ DATE _____
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 CHAIRMAN _____ DATE _____

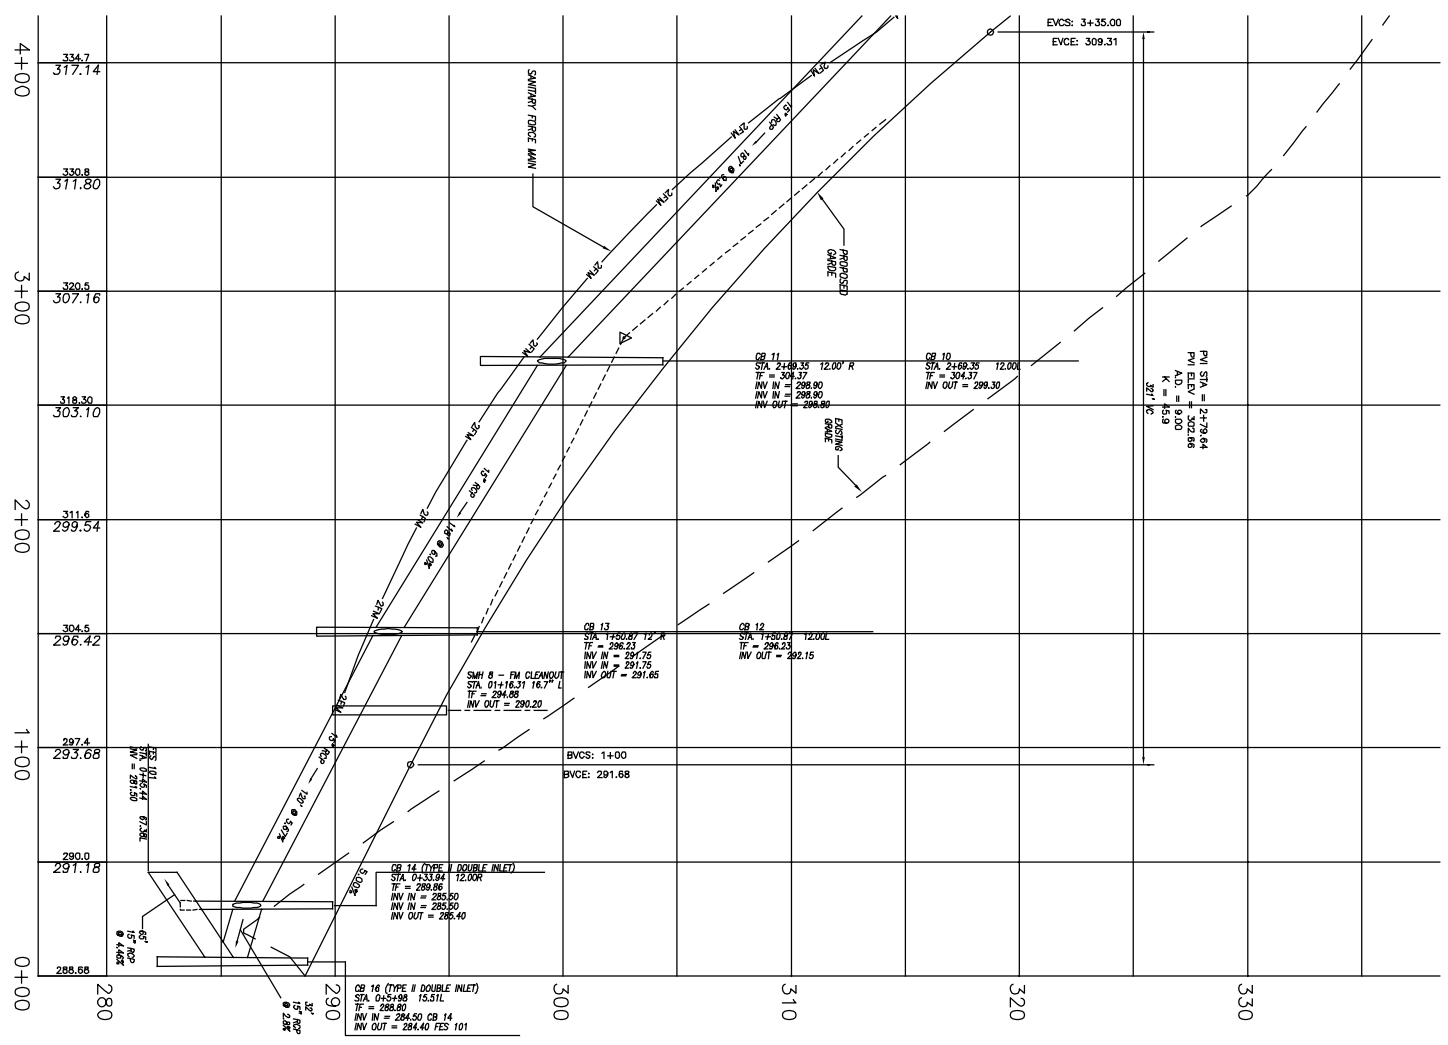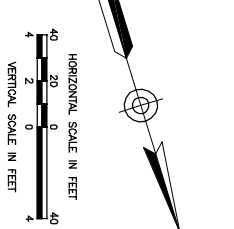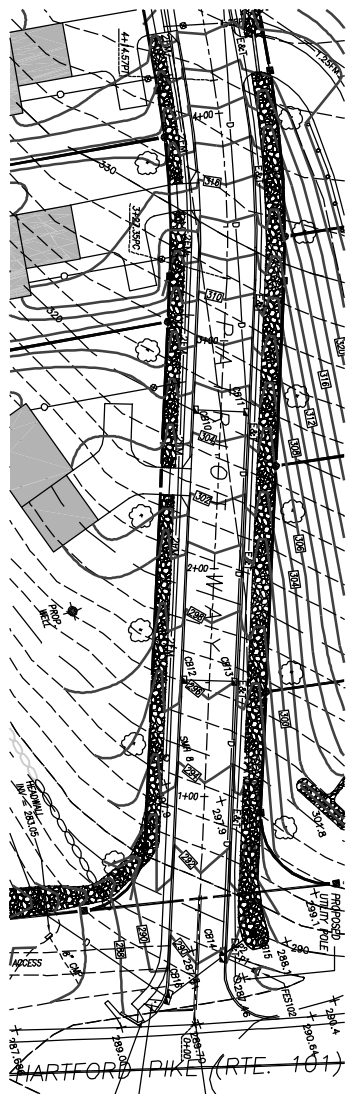FOR ALL STORM DRAINAGE AND SANITARY SEWER STRUCTURE SCHEDULES SEE SHEET 8.

BEFORE YOU DIG CALL BEFORE YOU DIG
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 DIAL 811 OR 1-800-922-4455

- LEGEND**
- IRON PIN TO BE SET
 - IRON PIN FOUND
 - DRILL HOLE FOUND
 - CONCRETE MONUMENT TO BE SET
 - WATER GATE
 - EXISTING CATCH BASIN
 - EXISTING SANITARY SEWER MANHOLE
 - PROPOSED SANITARY SEWER MANHOLE
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 - PROPOSED OVERHEAD WIRES
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 - STONE WALL REMAINS
 - SILT FENCE

DATE	DESCRIPTION
4/06/2020	PER ENGINEERING REVIEW
3/12/2020	CITIZEN COMMENTS
2/20/2020	FINAL PLAN REVIEW
DATE	DESCRIPTION



PROPOSED PLAN & PROFILE NO. 1
 STATION 1+00 TO 9+00
 PREPARED FOR

PATRIOT HOMES, LLC

HARTFORD PIKE (ROUTE 101)
 KILLINGLY, CONNECTICUT

Killingly Engineering Associates
 Civil Engineering & Surveying
 111 Western Blvd
 P.O. Box 430
 Killingly, Connecticut 06241
 (860) 739-7299
 www.killinglyengineering.com

DATE: 1/15/2020	DRAWN: AMR
SCALE: 1" = 40'	DESIGN: NET
SHEET: 7 OF 14	CHK BY: GS
DWG. NO: CLIENT FILE	JOB NO: 16130

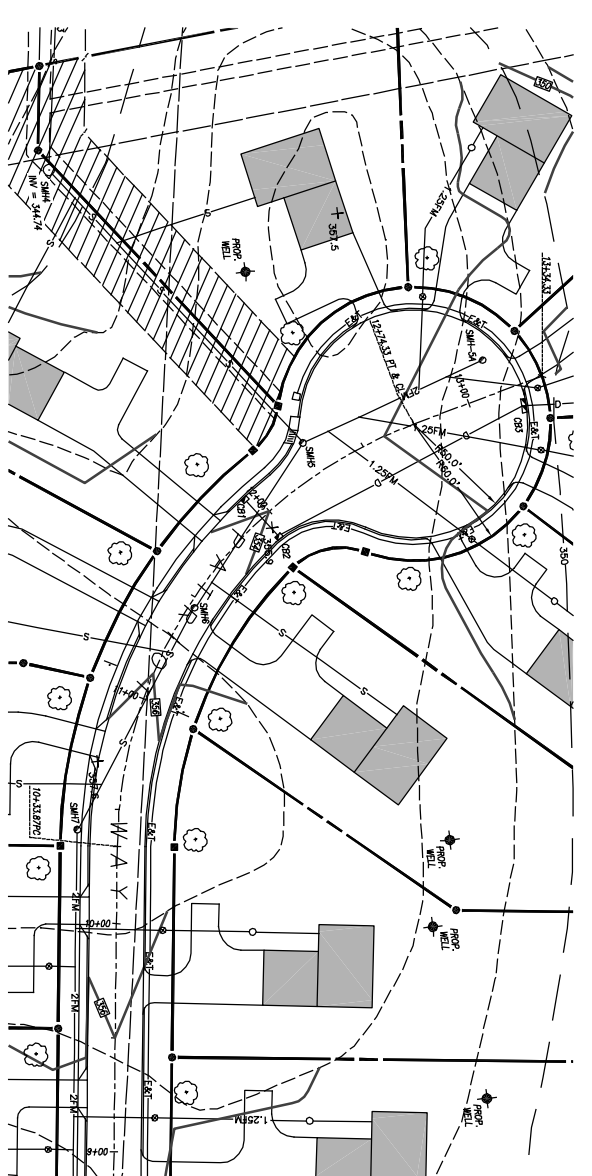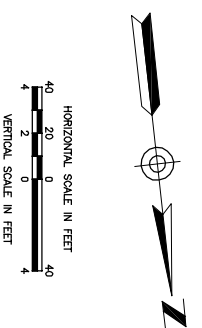

SEWERAGE SCHEDULE


STRUCTURE ID	STRUCTURE TYPE	FRAME ELEV.	PIPE INVERT ELEVATION			OUTLET DIA. (IN.)	MATERIAL	LENGTH (FT.)	SLOPE (%)
			N	S	E				
SMH-6	CLEAN-OUT	394.88		OUT = 290.20		2	PVC	106	
SMH-7	MANHOLE	357.07		OUT = 327.54	IN = 347.64	8	PVC	1.0%	
SMH-8	MANHOLE	355.11		OUT = 346.54	IN = 346.44	8	PVC	1.0%	
SMH-5	MANHOLE	352.86		OUT = 346.54	IN = 346.44	8	PVC	1.0%	
SMH-5A	CLEAN-OUT	350.81		OUT = 346.80		2			

STORM DRAINAGE SCHEDULE

STRUCTURE ID	STRUCTURE TYPE	FRAME ELEV.	PIPE INVERT ELEVATION			OUTLET DIA. (IN.)	MATERIAL	LENGTH (FT.)	SLOPE (%)
			N	S	E				
CB-15	C-L			OUT = 285.40		15	RCP		
FES-102	FLARED END	288.86		IN = 285.50		15	RCP		
CB-14	II DOUBLE	288.80		OUT = 284.40		15	RCP		
CB-16	II DOUBLE	288.80		OUT = 284.50		15	RCP		
FES-101	FLARED END	288.80		OUT = 281.50		15	RCP		
CB-13	C	288.23		OUT = 291.65	IN = 291.75	15	RCP		
CB-12	C	288.23		OUT = 288.80	IN = 288.80	15	RCP		
CB-11	C	304.37		OUT = 298.80	IN = 298.80	15	RCP		
CB-10	C	304.37		OUT = 316.38	IN = 316.38	15	RCP		
CB-9	C	323.60		OUT = 316.78	IN = 316.38	15	RCP		
CB-8	C	343.80		OUT = 344.07	IN = 344.87	15	RCP		
CB-7	C	343.80		OUT = 341.07	IN = 344.87	15	RCP		
CB-6	C	343.80		OUT = 346.44	IN = 346.30	15	RCP		
CB-4	C	253.66		OUT = 346.20	IN = 346.20	15	RCP		
CB-3	II DOUBLE	353.70		OUT = 348.60	IN = 348.60	15	RCP		
CB-2	C	353.70		OUT = 348.00	IN = 348.60	15	RCP		
CB-1	C	353.70		OUT = 348.00	IN = 348.60	15	RCP		
FES-103	FLARED END	353.70		OUT = 337.77		15	RCP		

PIPE ID	N	S	E	W	OUTLET DIA. (IN.)	MATERIAL	LENGTH (FT.)	SLOPE (%)
P-1	IN: 777.27 (FES-102)	OUT: 777.27 (CB-14)	OUT: 222.27 (CB-14)	IN: 777.27 (CB-15)				
P-2			OUT: 222.27 (CB-14)	IN: 777.27 (CB-5)				
P-3			OUT: 222.27 (FES-103)					

HIGH POINT ELEV. = 356.83
 LOW POINT ELEV. = 352.23
 PM STA = 10+34.71
 PI ELEV. = 357.80
 A.O. = -2.68
 K = 28.00
 182.2' R

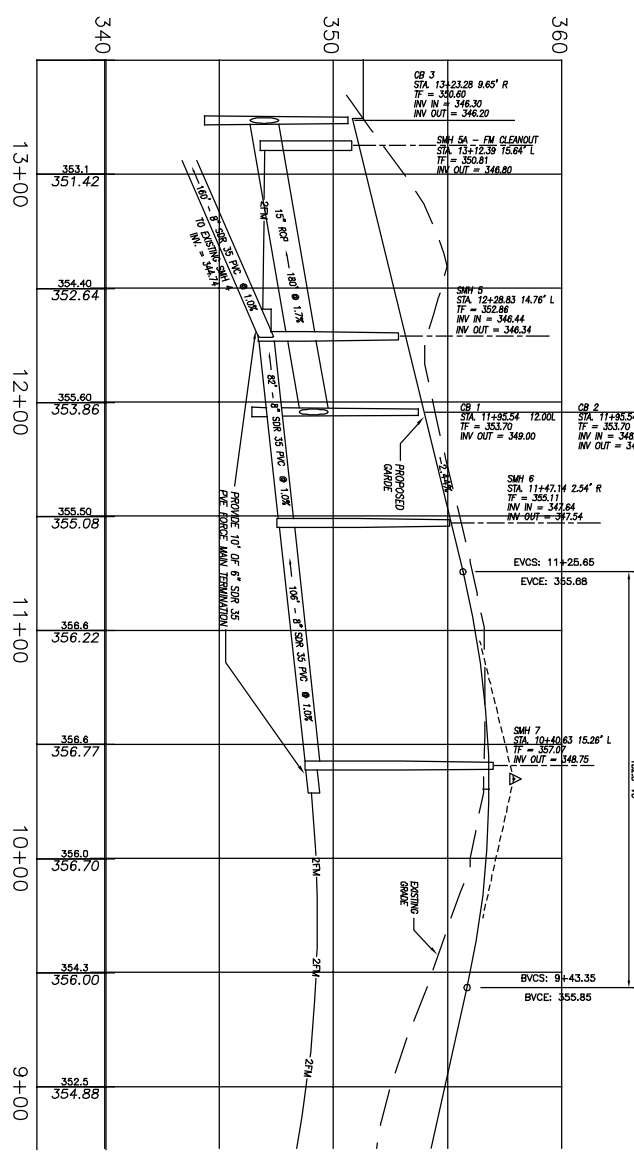

- LEGEND**
- IRON PIN TO BE SET
 - DRILL HOLE FOUND
 - CONCRETE MONUMENT TO BE SET
 - WATER GATE
 - EXISTING CATCH BASIN
 - PROPOSED CATCH BASIN
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 - PROPOSED OVERHEAD WIRES
 - ○ ○ ○ ○ STONE WALL
 - ○ ○ ○ ○ STONE WALL REMAINS
 - SILT FENCE

Subdivision Plan No.: _____

APPROVED BY THE TOWN OF KILLINGLY PLANNING AND ZONING COMMISSION

CHAIRMAN _____ DATE _____

EXpiration date per Sec. 8-26a, Conn. Gen. Statutes: _____

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CHAIRMAN _____ DATE _____

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 DIAL 811 OR 1-800-922-4455

NORMAN E. THIBOUTT, JR., P.E.

DATE _____


PROPOSED PLAN & PROFILE NO. 2
 STATION 9+00 TO 14+00
 PREPARED FOR
PATRIOT HOMES, LLC
 HARTFORD PIKE (ROUTE 101)
 KILLINGLY, CONNECTICUT

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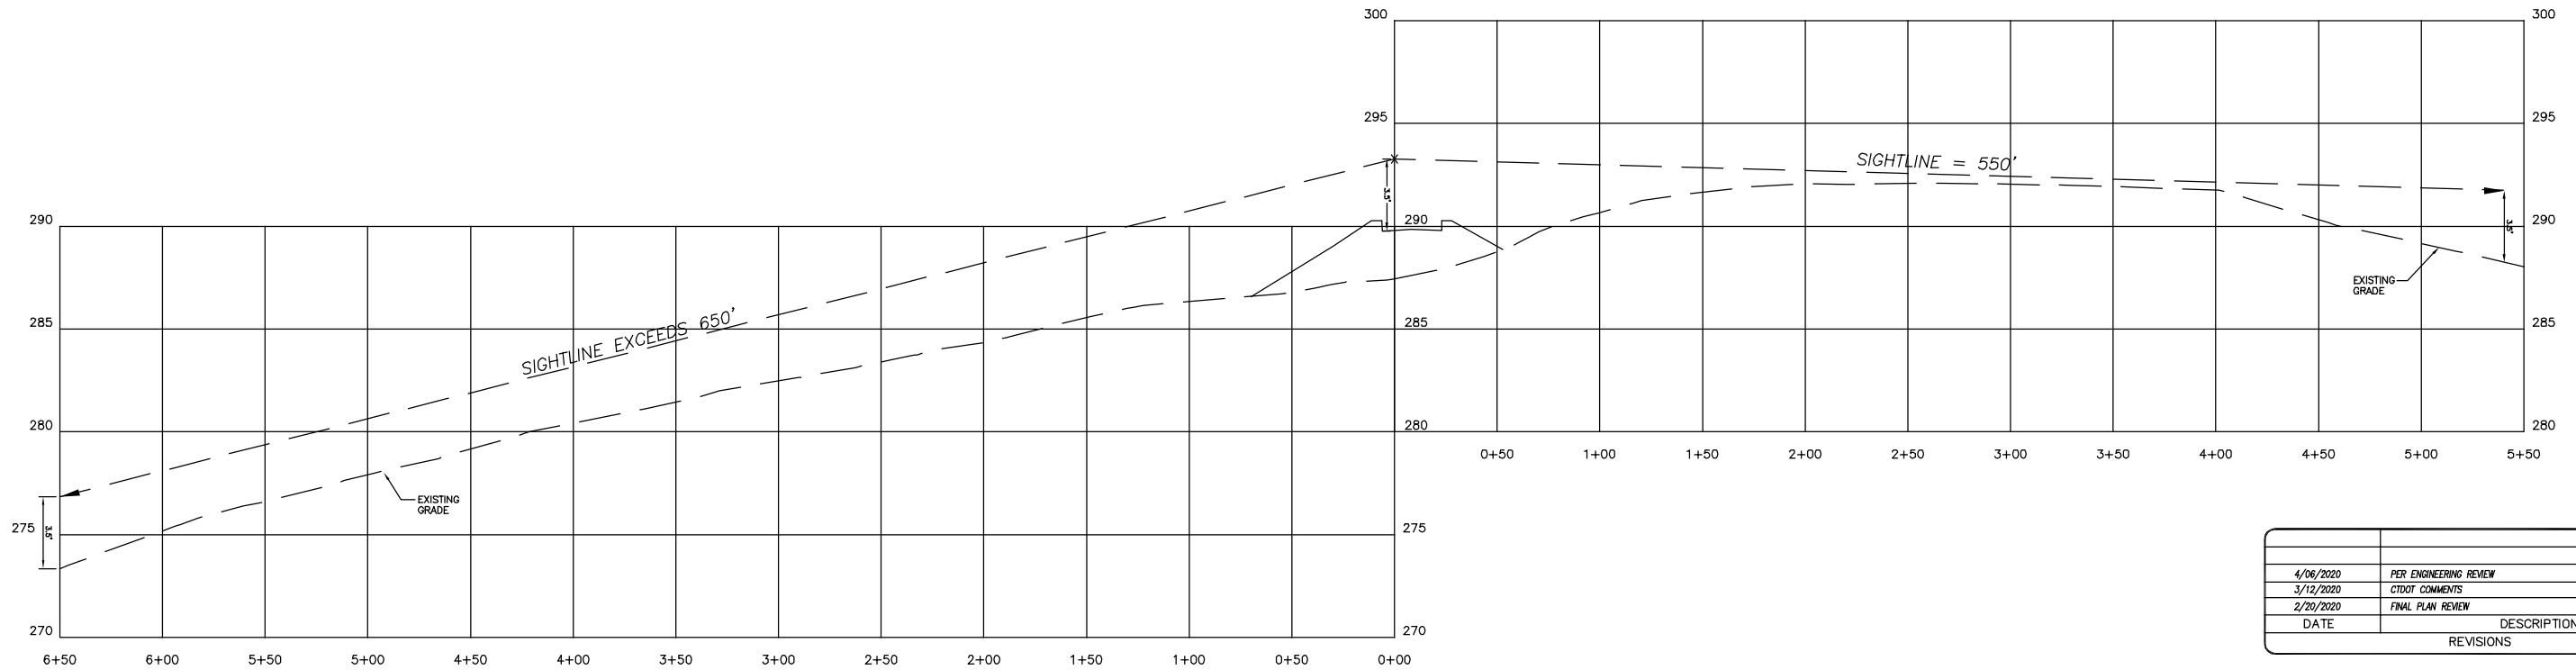
DATE: 1/15/2020
 SCALE: 1" = 40'
 SHEET: 8 OF 14
 DWS: NO. CLIENT FILE

DRINK: AMR
 DESIGN: NET
 CHK BY: GS
 JOB NO.: 16130


4/06/2020 PER ENGINEERING REVIEW
 3/12/2020 CIVIL COMMENTS
 2/20/2020 FINAL PLAN REVIEW
 DATE DESCRIPTION REVISIONS

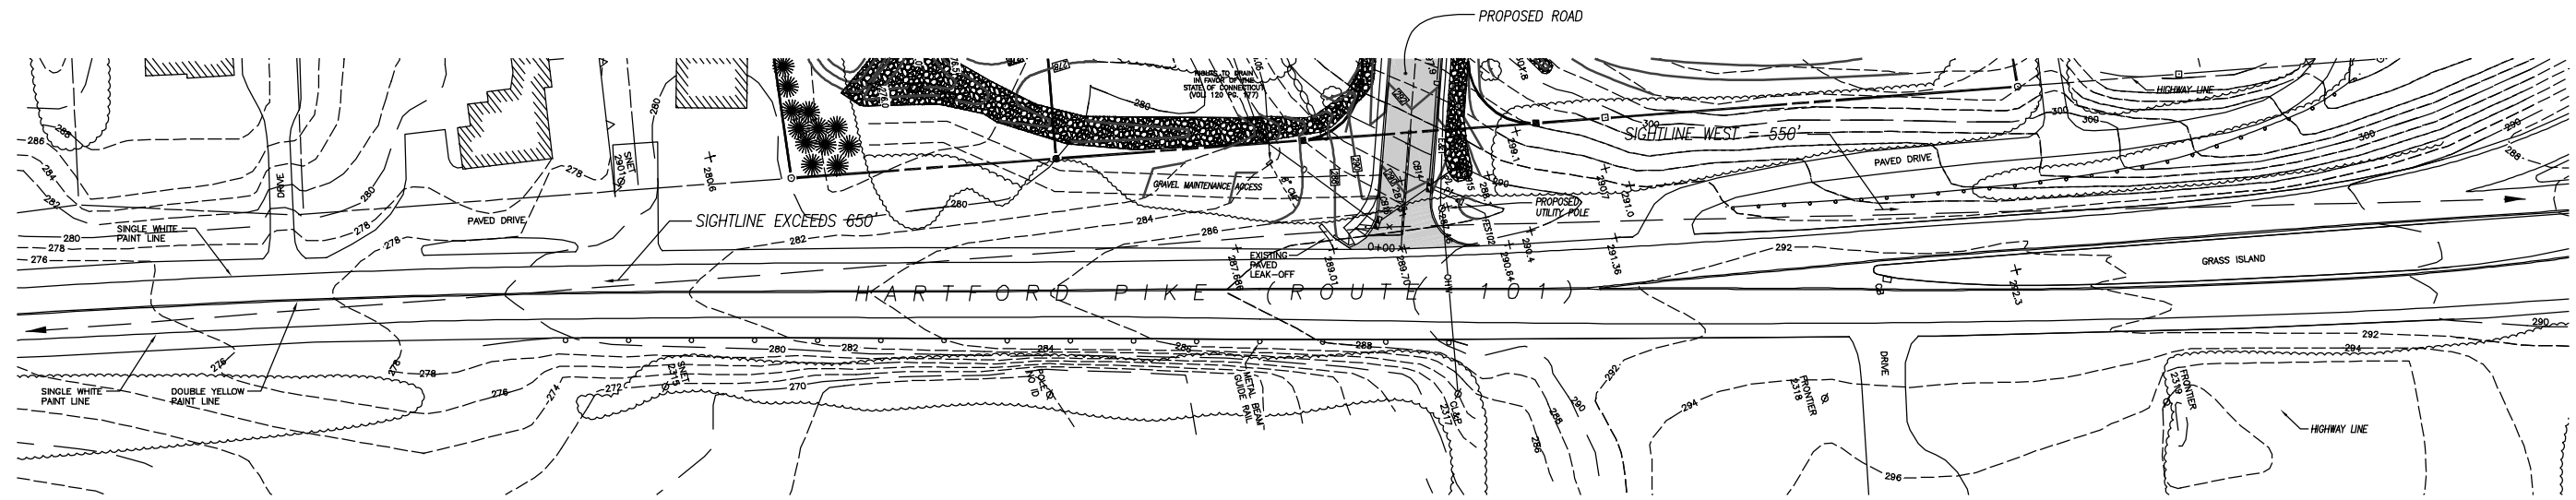

SIGHTLINE PLAN VIEW



SIGHTLINE PROFILE

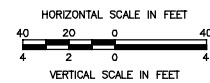


DATE	DESCRIPTION
4/06/2020	PER ENGINEERING REVIEW
3/12/2020	CTDOT COMMENTS
2/20/2020	FINAL PLAN REVIEW

SIGHTLINE DEMONSTRATION PLAN
PREPARED FOR

PATRIOT HOMES, LLC

HARTFORD PIKE (ROUTE 101)
KILLINGLY, CONNECTICUT

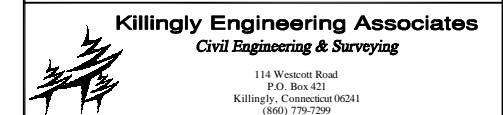

DATE: 1/15/2020	DRAWN: AMR
SCALE: 1" = 40'	DESIGN: NET
SHEET: 9 OF 14	CHK BY: GG
DWG. No: CLIENT FILE	JOB No: 16130


Subdivision Plan No:
APPROVED BY THE TOWN OF
KILLINGLY PLANNING AND ZONING COMMISSION
CHAIRMAN _____ DATE _____
Expiration date per Sec. 8.26c, Conn. Gen. Statutes: _____

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KILLINGLY INLAND WETLANDS COMMISSION
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DIAL 811 OR 1-800-922-4455

NORMAND E. THIBEAULT, JR., P.E. _____ DATE _____



HARTFORD PIKE (ROUTE 101)

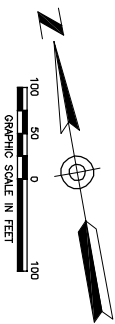

HISTORICAL DATA						
LOT #	GRANTOR	GRANTEE	VOL.	PG.	DATE	NOTES
4 & 30	PATRIOT HOMES, LLC	JILL MARQUARDT, TRUSTEE	1328	16	11/29/2017	BOUNDARY ADJUSTMENT & PARCEL CONSOLIDATION
FORMER LOT 30	JAMES E. GAUDREAU CLAIR M. GAUDREAU	JILL MARQUARDT, TRUSTEE	949	379	7/14/2004	4 1/4 ACRES
FORMER LOT 30	JANE G. RACOCOT	JAMES E. GAUDREAU CLAIR M. GAUDREAU	668	91	11/15/1996	4 1/4 ACRES
FORMER LOT 30	LEONARD G. BISSONNETTE	JANE G. RACOCOT	581	130	8/25/1993	4 1/4 ACRES
FORMER LOT 30	ESTATE OF ALDEA BISSONNETTE	LEONARD G. BISSONNETTE, ET AL.	282	183	10/27/1981	4 1/4 ACRES
FORMER LOT 30	ESTATE OF ALBERT BISSONNETTE	ALDEA BISSONNETTE	290	99	3/09/1979	2ND TRACT 4 1/4 ACRES
FORMER LOT 30	ESTATE OF JOHN COMMY	ALBERT BISSONNETTE	89	577	8/27/1937	1ST TRACT 4 1/4 ACRES

"OPEN SPACE PARCEL"
CONVEYED BY MAP 1107, PG. 439
(SEE VOL. 1507, PG. 439)

"BOUNDARY ADJUSTMENT"
(SEE VOL. 1328, PG. 16)

MAP 112 LOT 30
"JILL MARQUARDT SUBDIVISION"
APPROVED 2018

CARDINAL DRIVE

Subdivision Plan No: _____
APPROVED BY THE TOWN OF KILLINGLY PLANNING AND ZONING COMMISSION
CHAIRMAN _____ DATE _____
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APPROVED BY THE TOWN OF KILLINGLY INLAND WETLANDS COMMISSION
CHAIRMAN _____ DATE _____

TO MY KNOWLEDGE AND BELIEF, THIS MAP IS SUBSTANTIALLY CORRECT AS NOTED HEREON,
GREG A. GLAUDE, L.S. I.C. NO. 70191 DATE _____
NO CERTIFICATION IS EXPRESSED OR IMPLIED UNLESS THIS MAP BEARS THE ORIGINAL SEAL AND SIGNATURE OF THE LAND SURVEYOR.


DATA ACCUMULATION MAP
PARCEL HISTORY
PREPARED FOR
PATRIOT HOMES, LLC
HARTFORD TURNPIKE (ROUTE 101)
KILLINGLY, CONNECTICUT

Killingly Engineering & Surveying
Civil Engineering & Surveying
111 Westcott Blvd
P.O. Box 43
Killingly, Connecticut 06241
(860) 798-7299
www.killinglyengineering.com

DATE: 1/15/2020	DRAWN: AAR
SCALE: 1" = 100'	DESIGN: NET
SHEET: 10 OF 14	CHK. BY: GS
DWG. NO: CLIENT FILE	JOB NO: 16130



DATE	DESCRIPTION	REVISIONS
4/06/2020	PER ENGINEERING REVIEW	
3/12/2020	CITY COMMENTS	
2/20/2020	FINAL PLAN REVIEW	

NOTES:
This survey has been prepared pursuant to the Regulations of the Connecticut State Department of Transportation through 20-300R-20 and the "Standards for Surveys and Maps in the State of Connecticut" as adopted by the Connecticut Association of Land Surveyors, Inc. on September 26, 1996.
- This survey conforms to a Class "B" horizontal accuracy.
- Survey Type: Completion Plan.
This plan was compiled from other maps, record research or other sources of information. It is not to be construed as having been obtained as the result of a field survey, and is subject to such change as an accurate field survey may disclose.

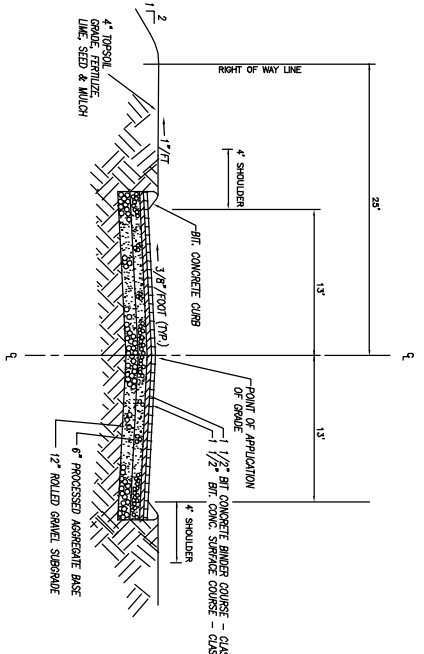


ROADWAY CROSS SECTION
NOT TO SCALE



TYPICAL CROSS SECTION FOR PAVEMENT
EXISTING AND PROPOSED MATCHING
NOT TO SCALE

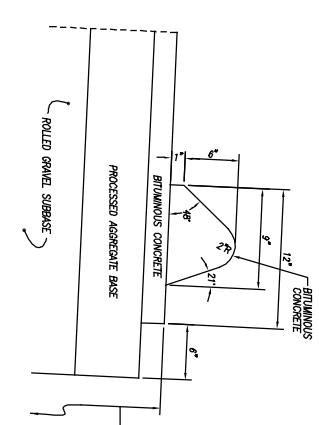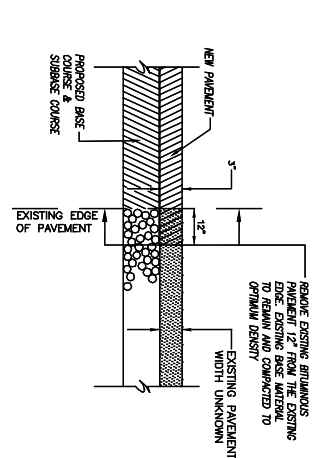

SIDEWALK RAMP TYPE 4C
NOT TO SCALE

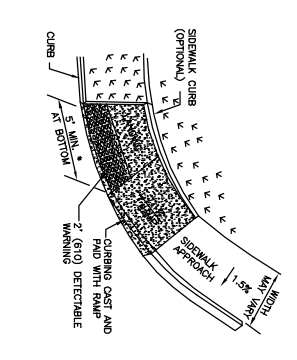


DIAGONAL SIDEWALK RAMP
WITH LANDING AT TOP
(TYPE 4)
NOT TO SCALE

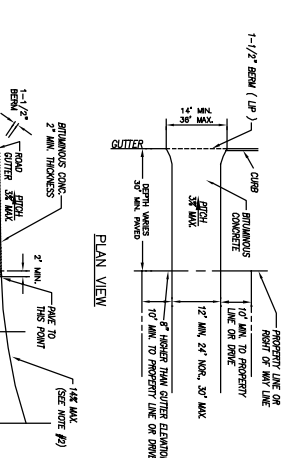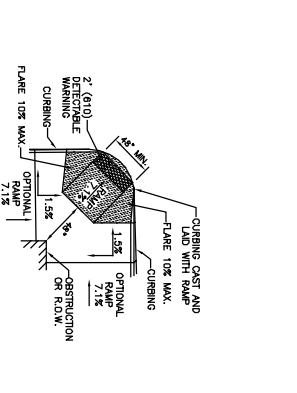

LAND ABOVE ROAD
(SECTION)


LAND BELOW ROAD
(SECTION)

STANDARD DRIVE DETAIL
NOT TO SCALE


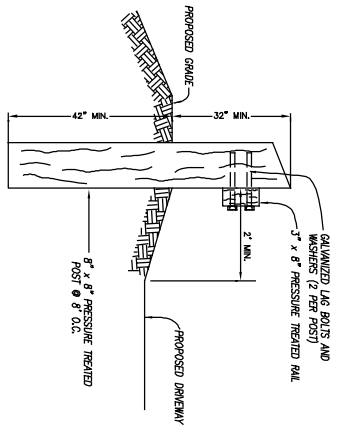


WOOD GUIDE RAIL
NOT TO SCALE

STOP SIGN
NOT TO SCALE

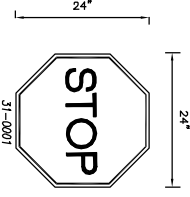

PANTING CROSS SECTION
FOR TREES UNDER 20'
NOT TO SCALE

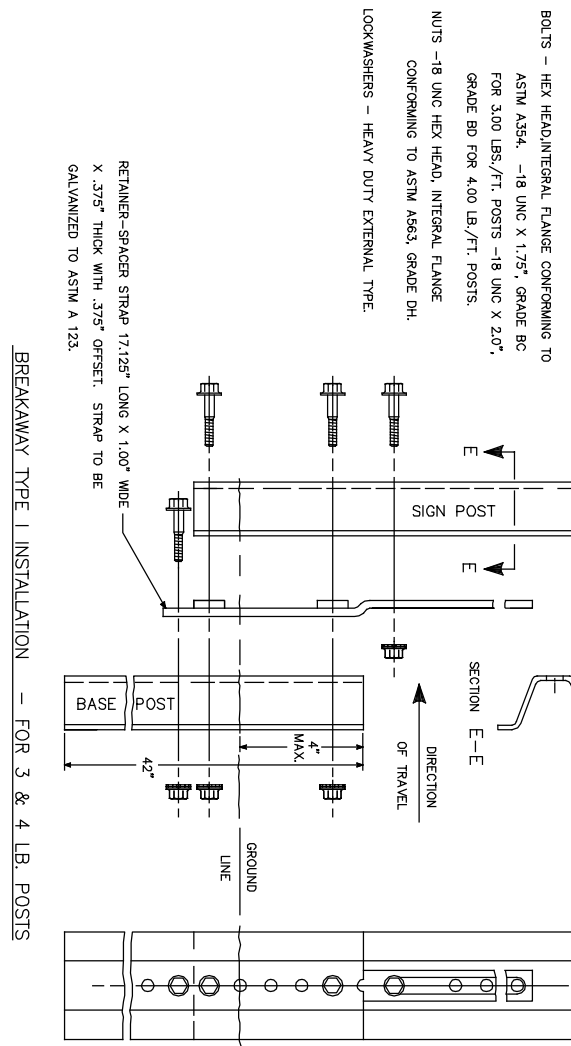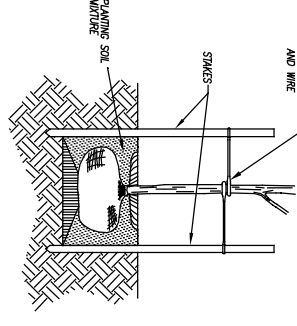

BREAKAWAY TYPE 1 INSTALLATION - FOR 3 & 4 LB. POSTS

DATE	DESCRIPTION
4/06/2020	PER ENGINEERING REVIEW
3/12/2020	CITY COMMENTS
2/20/2020	FINAL PLAN REVIEW
DATE	DESCRIPTION
REVISIONS	

DETAIL SHEET No. 2
PREPARED FOR
PATRIOT HOMES, LLC
HARTFORD PIKE (ROUTE 101)
KILLINGLY, CONNECTICUT

Killingly Engineering Associates
Civil Engineering & Surveying


111 Weston Blvd
P.O. Box 431
Killingly, Connecticut 06241
(860) 779-7299
www.killinglyengineering.com

Subdivision Plan No:
APPROVED BY THE TOWN OF
KILLINGLY PLANNING AND ZONING COMMISSION
CHAIRMAN _____ DATE _____
Expiration date per Sec. 8-26c, Conn. Gen. Statutes: _____


ANY CHANGES TO THESE PLANS WITHIN 200' OF WETLANDS OR WATERCOURSES MUST BE RESUBMITTED TO THE KILLINGLY INLAND WETLANDS AND WATERCOURSES COMMISSION FOR ITS APPROVAL.
THE APPLICANT WILL CONTRACT THE KILLINGLY INLAND WETLANDS AND WATERCOURSES COMMISSION'S AGENT AND SHALL BE RESPONSIBLE FOR OBTAINING ALL NECESSARY PERMITS AND INSTALLATION PRIOR TO ANY CONSTRUCTION OR EXCAVATION ON THE PROPERTY.

APPROVED BY THE TOWN OF
KILLINGLY INLAND WETLANDS COMMISSION
CHAIRMAN _____ DATE _____


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SCALE:	NOT TO SCALE	DESIGN:	NET
SHEET:	12 OF 14	CHK. BY:	GG
DWG. NO. CLIENT FILE		JOB NO.:	16130

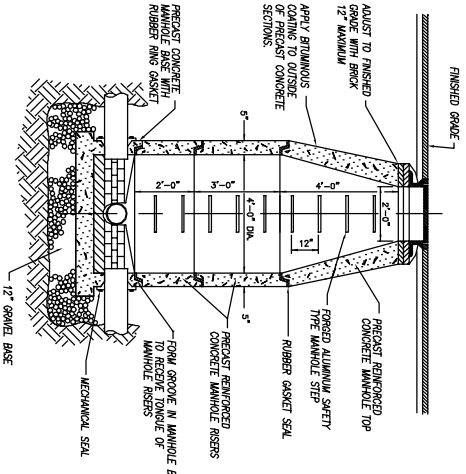


TYPICAL SANITARY MANHOLE
CROSS SECTION
NOT TO SCALE

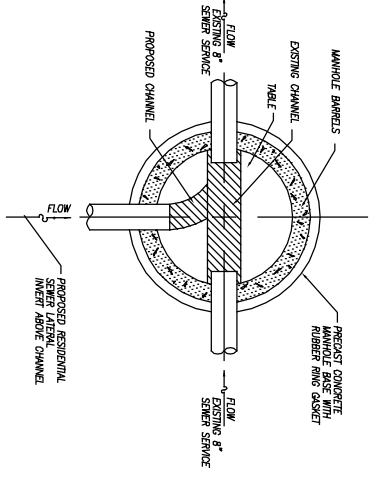



SEWER CONNECTION
AT MANHOLE
NOT TO SCALE

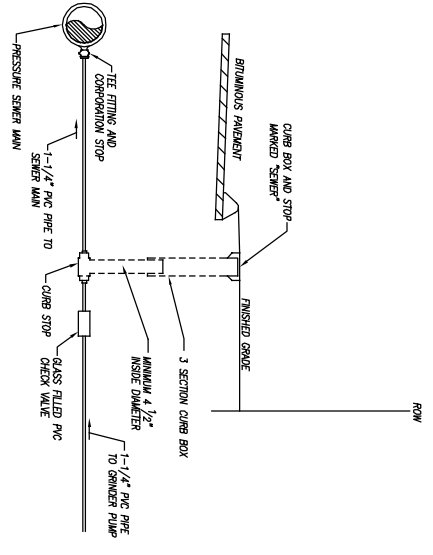


LOW PRESSURE SEWER SERVICE CONNECTION
NOT TO SCALE

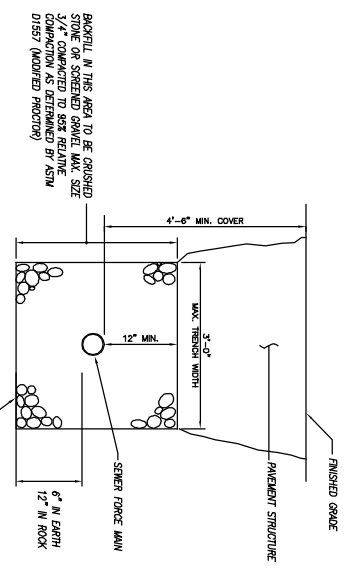


PRESSURE SEWER TRENCH DETAIL
NOT TO SCALE

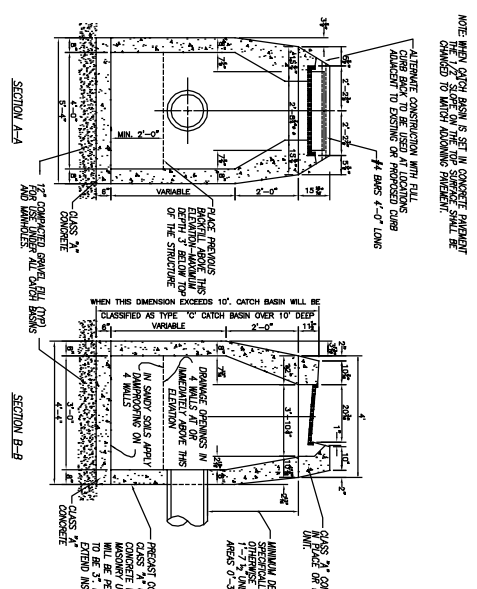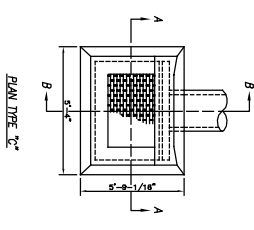


TYPE 'C' CATCH BASIN DOUBLE GRATE TYPE 1 DETAIL
NOT TO SCALE

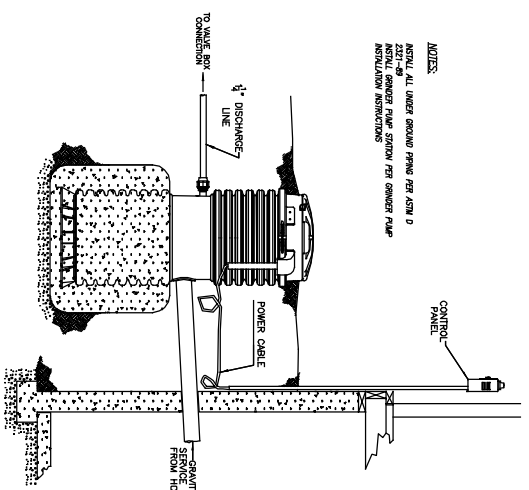

RESIDENTIAL LOW PRESSURE GRINDER PUMP SYSTEM
NOT TO SCALE

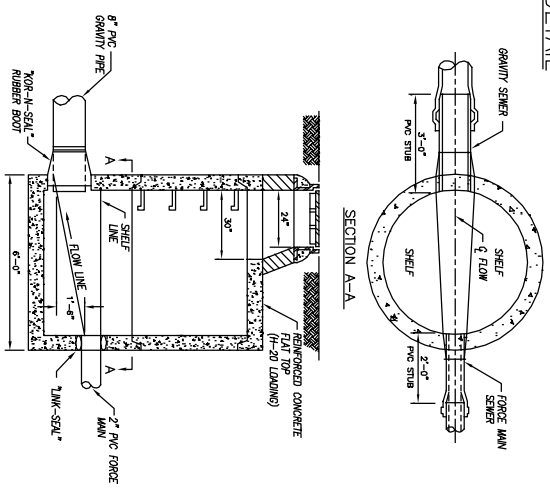


TRANSITION MANHOLE
NOT TO SCALE

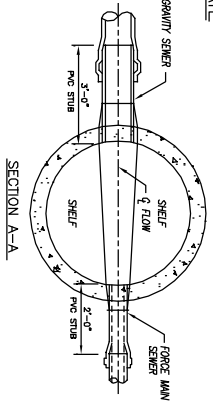


FLARED END SECTION
NOT TO SCALE

DIMENSIONS FOR REINFORCED CONCRETE											
DIA. A	B	C	D	E	F	R ₁	R ₂	FLARED			
								REINFORCED CONCRETE	REINFORCED CONCRETE	REINFORCED CONCRETE	REINFORCED CONCRETE
12"	4'-0"	4'-0"	4'-0"	4'-0"	4'-0"	1'-0"	1'-0"	0.004	0.004	0.004	0.004
14"	4'-0"	4'-0"	4'-0"	4'-0"	4'-0"	1'-0"	1'-0"	0.006	0.006	0.006	0.006
16"	4'-0"	4'-0"	4'-0"	4'-0"	4'-0"	1'-0"	1'-0"	0.008	0.008	0.008	0.008
18"	4'-0"	4'-0"	4'-0"	4'-0"	4'-0"	1'-0"	1'-0"	0.010	0.010	0.010	0.010
20"	4'-0"	4'-0"	4'-0"	4'-0"	4'-0"	1'-0"	1'-0"	0.012	0.012	0.012	0.012
22"	4'-0"	4'-0"	4'-0"	4'-0"	4'-0"	1'-0"	1'-0"	0.014	0.014	0.014	0.014
24"	4'-0"	4'-0"	4'-0"	4'-0"	4'-0"	1'-0"	1'-0"	0.016	0.016	0.016	0.016
26"	4'-0"	4'-0"	4'-0"	4'-0"	4'-0"	1'-0"	1'-0"	0.018	0.018	0.018	0.018
28"	4'-0"	4'-0"	4'-0"	4'-0"	4'-0"	1'-0"	1'-0"	0.020	0.020	0.020	0.020
30"	4'-0"	4'-0"	4'-0"	4'-0"	4'-0"	1'-0"	1'-0"	0.022	0.022	0.022	0.022
32"	4'-0"	4'-0"	4'-0"	4'-0"	4'-0"	1'-0"	1'-0"	0.024	0.024	0.024	0.024
34"	4'-0"	4'-0"	4'-0"	4'-0"	4'-0"	1'-0"	1'-0"	0.026	0.026	0.026	0.026
36"	4'-0"	4'-0"	4'-0"	4'-0"	4'-0"	1'-0"	1'-0"	0.028	0.028	0.028	0.028
38"	4'-0"	4'-0"	4'-0"	4'-0"	4'-0"	1'-0"	1'-0"	0.030	0.030	0.030	0.030
40"	4'-0"	4'-0"	4'-0"	4'-0"	4'-0"	1'-0"	1'-0"	0.032	0.032	0.032	0.032
42"	4'-0"	4'-0"	4'-0"	4'-0"	4'-0"	1'-0"	1'-0"	0.034	0.034	0.034	0.034
44"	4'-0"	4'-0"	4'-0"	4'-0"	4'-0"	1'-0"	1'-0"	0.036	0.036	0.036	0.036
46"	4'-0"	4'-0"	4'-0"	4'-0"	4'-0"	1'-0"	1'-0"	0.038	0.038	0.038	0.038
48"	4'-0"	4'-0"	4'-0"	4'-0"	4'-0"	1'-0"	1'-0"	0.040	0.040	0.040	0.040
50"	4'-0"	4'-0"	4'-0"	4'-0"	4'-0"	1'-0"	1'-0"	0.042	0.042	0.042	0.042
52"	4'-0"	4'-0"	4'-0"	4'-0"	4'-0"	1'-0"	1'-0"	0.044	0.044	0.044	0.044
54"	4'-0"	4'-0"	4'-0"	4'-0"	4'-0"	1'-0"	1'-0"	0.046	0.046	0.046	0.046
56"	4'-0"	4'-0"	4'-0"	4'-0"	4'-0"	1'-0"	1'-0"	0.048	0.048	0.048	0.048
58"	4'-0"	4'-0"	4'-0"	4'-0"	4'-0"	1'-0"	1'-0"	0.050	0.050	0.050	0.050
60"	4'-0"	4'-0"	4'-0"	4'-0"	4'-0"	1'-0"	1'-0"	0.052	0.052	0.052	0.052
62"	4'-0"	4'-0"	4'-0"	4'-0"	4'-0"	1'-0"	1'-0"	0.054	0.054	0.054	0.054
64"	4'-0"	4'-0"	4'-0"	4'-0"	4'-0"	1'-0"	1'-0"	0.056	0.056	0.056	0.056
66"	4'-0"	4'-0"	4'-0"	4'-0"	4'-0"	1'-0"	1'-0"	0.058	0.058	0.058	0.058
68"	4'-0"	4'-0"	4'-0"	4'-0"	4'-0"	1'-0"	1'-0"	0.060	0.060	0.060	0.060
70"	4'-0"	4'-0"	4'-0"	4'-0"	4'-0"	1'-0"	1'-0"	0.062	0.062	0.062	0.062
72"	4'-0"	4'-0"	4'-0"	4'-0"	4'-0"	1'-0"	1'-0"	0.064	0.064	0.064	0.064
74"	4'-0"	4'-0"	4'-0"	4'-0"	4'-0"	1'-0"	1'-0"	0.066	0.066	0.066	0.066
76"	4'-0"	4'-0"	4'-0"	4'-0"	4'-0"	1'-0"	1'-0"	0.068	0.068	0.068	0.068
78"	4'-0"	4'-0"	4'-0"	4'-0"	4'-0"	1'-0"	1'-0"	0.070	0.070	0.070	0.070
80"	4'-0"	4'-0"	4'-0"	4'-0"	4'-0"	1'-0"	1'-0"	0.072	0.072	0.072	0.072
82"	4'-0"	4'-0"	4'-0"	4'-0"	4'-0"	1'-0"	1'-0"	0.074	0.074	0.074	0.074
84"	4'-0"	4'-0"	4'-0"	4'-0"	4'-0"	1'-0"	1'-0"	0.076	0.076	0.076	0.076
86"	4'-0"	4'-0"	4'-0"	4'-0"	4'-0"	1'-0"	1'-0"	0.078	0.078	0.078	0.078
88"	4'-0"	4'-0"	4'-0"	4'-0"	4'-0"	1'-0"	1'-0"	0.080	0.080	0.080	0.080
90"	4'-0"	4'-0"	4'-0"	4'-0"	4'-0"	1'-0"	1'-0"	0.082	0.082	0.082	0.082
92"	4'-0"	4'-0"	4'-0"	4'-0"	4'-0"	1'-0"	1'-0"	0.084	0.084	0.084	0.084
94"	4'-0"	4'-0"	4'-0"	4'-0"	4'-0"	1'-0"	1'-0"	0.086	0.086	0.086	0.086
96"	4'-0"	4'-0"	4'-0"	4'-0"	4'-0"	1'-0"	1'-0"	0.088	0.088	0.088	0.088
98"	4'-0"	4'-0"	4'-0"	4'-0"	4'-0"	1'-0"	1'-0"	0.090	0.090	0.090	0.090
100"	4'-0"	4'-0"	4'-0"	4'-0"	4'-0"	1'-0"	1'-0"	0.092	0.092	0.092	0.092

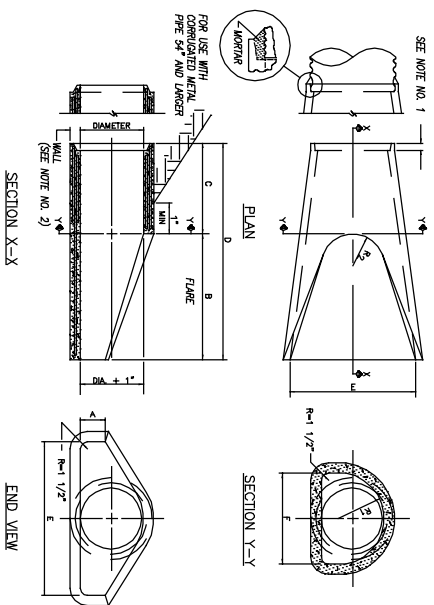

TYPICAL CATCH BASIN DETAIL
NOT TO SCALE

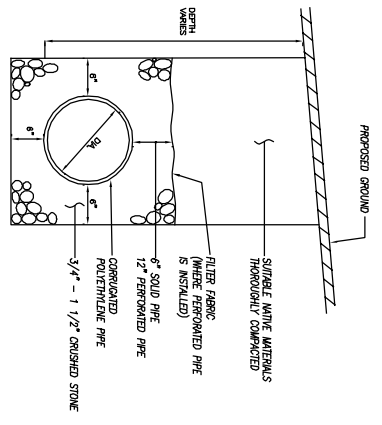

DRAINAGE PIPE INSTALLATION DETAIL
NOT TO SCALE

Subdivision Plan No: _____
APPROVED BY THE TOWN OF KILLINGLY PLANNING AND ZONING COMMISSION
CHAIRMAN _____ DATE _____
Expiration date per Sec. 8-26a, Conn. Gen. Statutes: _____

ANY CHANGES TO THESE PLANS WITHIN 200' OF WETLANDS OR WATERCOURSES MUST BE RESUBMITTED TO THE KILLINGLY INLAND WETLANDS AND WATERCOURSES COMMISSION FOR ITS APPROVAL.
THE APPLICANT WILL CONTRACT THE KILLINGLY INLAND WETLANDS AND WATERCOURSES COMMISSION'S AGENT FOR AN INLAND WETLANDS AND WATERCOURSES SURVEY AND INSTALLATION PRIOR TO ANY CONSTRUCTION OR EXCAVATION ON THE PROPERTY.
APPROVED BY THE TOWN OF KILLINGLY INLAND WETLANDS COMMISSION
CHAIRMAN _____ DATE _____

REVISIONS
DATE DESCRIPTION

DETAIL SHEET No. 3
PREPARED FOR
PATRIOT HOMES, LLC
HARTFORD PIKE (ROUTE 101)
KILLINGLY, CONNECTICUT



Killingly Engineering & Surveying
Civil Engineering & Surveying
111 Weston Blvd
P.O. Box 43
Killingly, Connecticut 06241
www.killinglyengineering.com

DATE: 1/15/2020
SCALE: NOT TO SCALE
SHEET: 13 OF 14
DWC: No. CLIENT FILE

DRINK: AIR
DESIGN: NET
CHK. BY: GS
JOB No.: 16130

DATE: _____
CHAIRMAN: _____

TABLE OF ZONING REQUIREMENTS	
ZONE = LOW DENSITY	REQUIRED
Lot Area	30,000 S.F.
Lot Frontage	100'
Front Yard Setback	40'
Side Yard Setback	20'
Rear Yard Setback	20'
Building Height	35' Max.
Lot Coverage	20% Max.

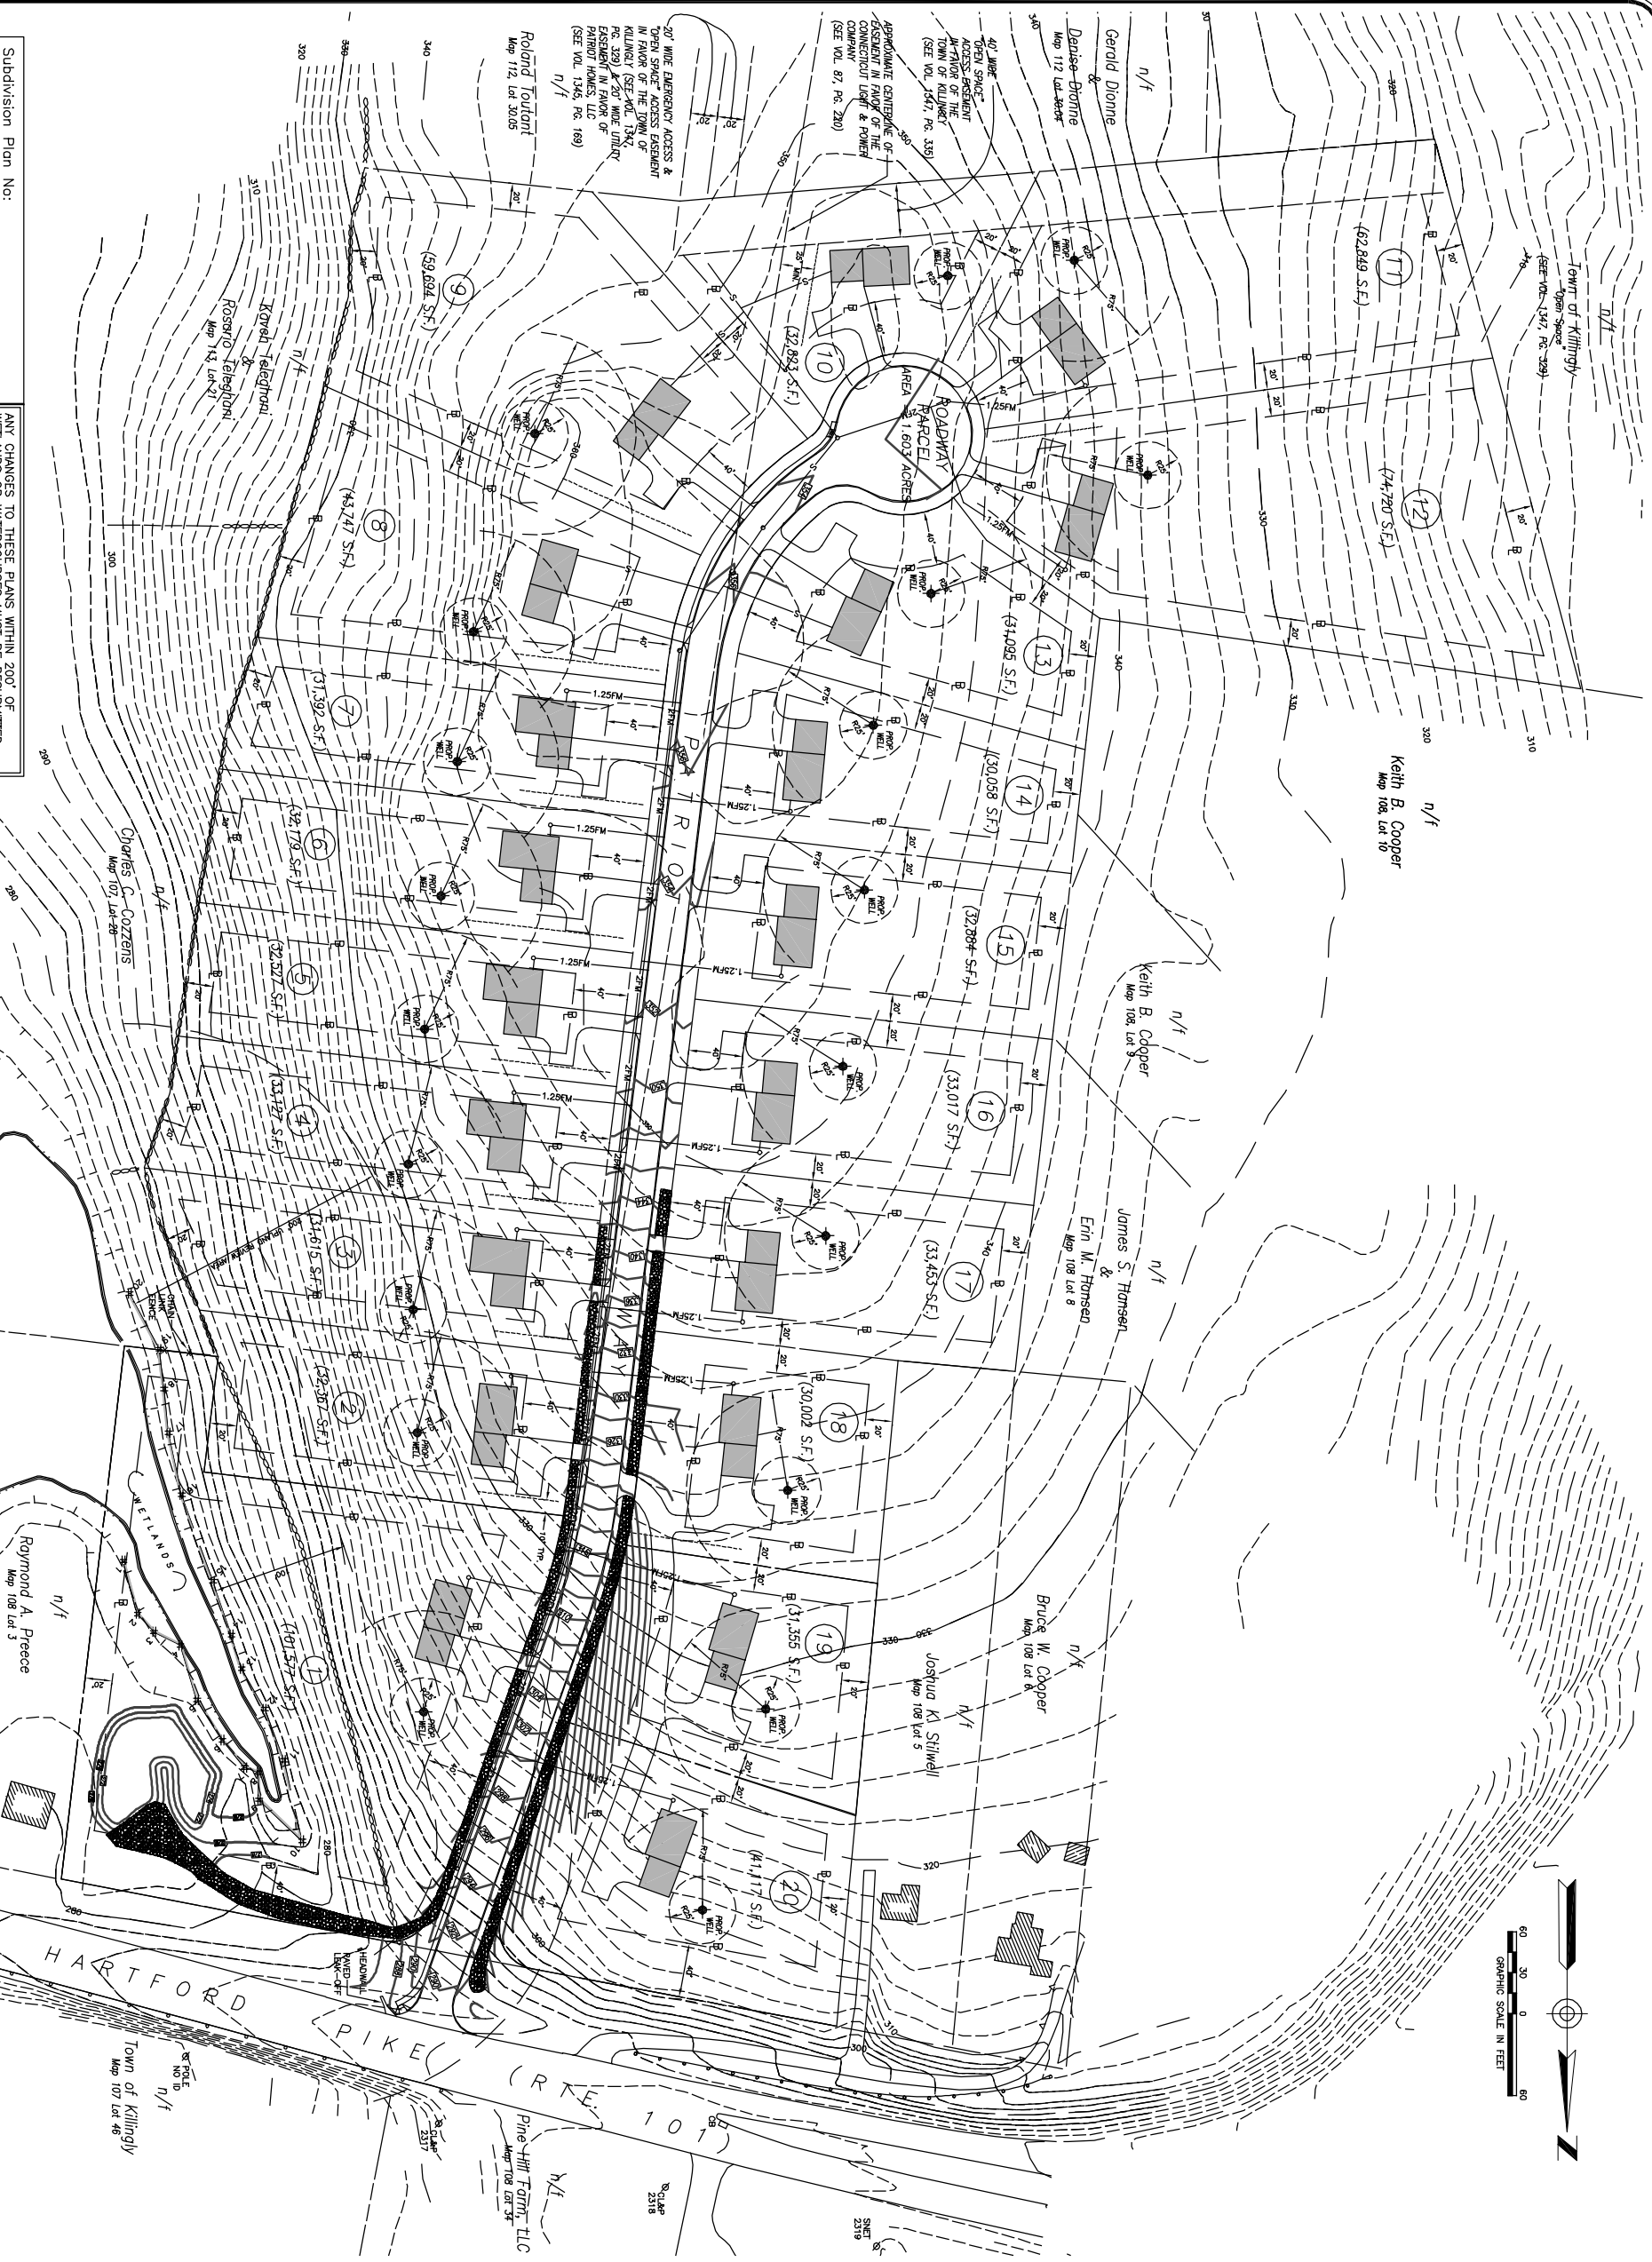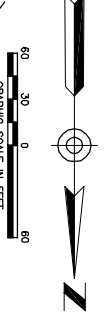

DATE	DESCRIPTION	REVISIONS
4/06/2020	PER ENGINEERING REVIEW	
3/12/2020	CITIC COMMENTS	
2/20/2020	FINAL PLAN REVIEW	

TRADITIONAL SUBDIVISION YIELD PLAN
 PREPARED FOR
PATRIOT HOMES, LLC
 HARTFORD PIKE (ROUTE 101)
 KILLINGLY, CONNECTICUT



DATE: 1/15/2020	DRAWN: AMR
SCALE: 1" = 60'	DESIGN: NET
SHEET: 14 OF 14	CHK. BY: GS
DWG. NO. CLIENT FILE	JOB NO. 16130

Subdivision Plan No: _____
 APPROVED BY THE TOWN OF
 KILLINGLY PLANNING AND ZONING COMMISSION
 CHAIRMAN _____ DATE _____
 ANY CHANGES TO THESE PLANS WITHIN 200' OF
 WETLANDS OR WATERCOURSES MUST BE RESUBMITTED
 TO THE KILLINGLY INLAND WETLANDS AND WATERCOURSES
 COMMISSION FOR ITS APPROVAL.
 THE APPLICANT WILL CONTRACT THE KILLINGLY INLAND
 WETLANDS AND WATERCOURSES COMMISSION'S AGENT
 FOR A FIELD VISIT PRIOR TO ANY CONSTRUCTION OR
 EXCAVATION ON THE PROPERTY.

APPROVED BY THE TOWN OF
 KILLINGLY INLAND WETLANDS COMMISSION
 CHAIRMAN _____ DATE _____

NORMAN THERIAULT, JR., P.E. No. 22334
 DATE _____

Telephone: (860) 974-0127
Fax: (860) 974-2963



101 Hampton Road
Pomfret Center, CT 06259

June 22, 2020

Conserving Forests / Crafting Wood / Since 1965

Jonathan Blake
Killingly Town Hall
172 Main St
Killingly, CT 06239

Dear Mr. Blake,

Enclosed please find the Notification of Timber Harvest Form and a Timber Harvest Map regarding a project Hull Forest Products, Inc. plans to conduct on approximately 90 of the 129 acres west of Roth Rd owned by James and Sheila Ilewicz. This operation involves a salvage harvest of the Oak trees that have died as a result of repetitive Gypsy Moth Defoliation and subsequent drought, a presalvage harvest of the Ash trees ahead of their eminent demise from the Emerald Ash Borer and an improvement thinning of the residual stand. The property boundaries have been identified in with pink ribbon and the trees to be harvested have been marked with blue paint marks at eye level. This harvest will be conducted as a conventional operation where the marked trees will be felled and a skidder or forwarder will be used to transport the merchantable logs to the yarding area where they will be hauled off site via an existing access road off Stafford St. A clean stone anti-tracking pad shall be installed where the existing access road meets Roth Rd. The tops of the trees and residual branches will be slashed in place to within three feet of the forest floor. There are four intermittent drainage crossings associated with this operation which have been identified in the field with four blue paint marks. Temporary timber bridges and/or corduroy will be installed as needed to stabilize the crossings during the operation. It is estimated that 6-8 weeks of good working weather will be required to complete this project.

We understand the sensitivity of this site and all Best Management Practices regarding Timber Harvesting as adopted by the CT DEEP will be strictly adhered to. It is our understanding that this type of agricultural activity is permitted as a Use of Right and hope that upon your review you will find the same. Please contact me if there is any other information you may need or if you would like to visit the site together.

Respectfully Submitted,

A handwritten signature in blue ink, appearing to read "Chris Casadei", is written over the typed name.

Chris Casadei
Forester

RECEIVED

JUN 29 2020

**PLANNING & ZONING DEPT.
TOWN OF KILLINGLY**

TIMBER HARVEST MAP
PROPERTY OF
JAMES AND SHEILA HEWICZ
61 ROTH RD
E. KILLING, CT
129.47 AC



PREPARED BY
C. CASADEI
HULL FOREST
PRODUCTS, INC.
JUNE 2020

ROTH RD

TUCKER DISTRICT RD

CUTLER RD

LEGEND

- PROPERTY BOUNDARY
- YARDING AREA
- TRUCK HAUL ROAD
- MAIN SKID TRAIL
- INTERMITTENT DRAINAGE
- TEMPORARY DRAINAGE CROSSING
- NO HARVEST AREA
- WETLAND



NOTIFICATION OF TIMBER HARVEST

Town: Killingly Date: 6/22/20
Property Location: 81 Roth Rd

List all parcels:

Assessor's Info:

Map	Block	Lot
11		1
11		2
5		6.1
22		4

OR:

Unique ID

Total acreage of property(s): 129.42 Total acreage of harvest area: 90

Landowner(s) of Record: James and Sheila Ilewicz
Mailing Address: 81 Roth Rd
Town: Killingly, CT Zip 06241
Phone (203) 376-3651
E-mail: _____

Primary Contact: Chris Casadei
Mailing Address: see below
Town: _____ Zip _____
Phone () _____
E-mail: _____

Note: Timber harvesting is a *Permitted as of Right Activity* pursuant to the Inland Wetlands and Watercourses Act, except for those practices regulated under Section 22a-36 through 22a-45 of the Connecticut General Statutes.

Is there a current forest management/stewardship plan for this property? Yes No

This timber harvest has been prepared by a State of Connecticut certified:
(Check one): Forester OR Supervising Forest Products Harvester
Forest Practitioner Certificate #: F-463
Name: Chris Casadei c/o Hull Forest Products, Inc.
Address: 101 Hampton Rd, Pomfret Center, CT 06259
E-mail: casadei@hullforest.com
Phone #: (Business) 860-974-0127 (Cell) 860-235-6550

Property Boundaries:

Bounds are marked: Yes No

Timber Harvest Boundaries:

Have been marked or flagged: Yes No

Have owners of all lands within 100 feet of the harvest area been notified via first-class mail prior to filing this "Notification of Timber Harvest"? Yes No

Estimated starting date of timber harvesting operations: 7 / 12 / 20

Description of Timber Harvest:

Objective: Mortality Salvage of Oak, Presalvage of Ash, improve residual stand

Treatment: selection harvest

Amount of forest products to be harvested:

154,070 Board feet 104 Cords _____ Cubic feet _____ Tons

How have the trees to be harvested been designated?

They have been marked with paint at eye level and at ground level. Paint color(s): Blue

They have not been marked

This is not an official CT DEP form but it has been endorsed for town usage by: CT Farm Bureau Assoc., CT Forest & Park Assoc., CT Professional Timber Producers, Society of American Foresters - CT Chapter, and others.

SOIL, WATER AND INLAND WETLANDS RESOURCES

Actions Being Performed On This Land

(Check all that apply and locate on attached Timber Harvest Area map -- see information below on maps.)

<p style="text-align: center;"><u>Crossings / Clearing</u></p> <input checked="" type="checkbox"/> Temporary stream/drainage crossing <input checked="" type="checkbox"/> Temporary wetlands crossing <input checked="" type="checkbox"/> Removal of trees in wetlands <input checked="" type="checkbox"/> Removal of trees in upland review area	<p style="text-align: center;"><u>Erosion and Sedimentation Control Measures:</u></p> <input checked="" type="checkbox"/> Installation of water bars <input checked="" type="checkbox"/> Grading <input type="checkbox"/> Seeding <input type="checkbox"/> Other (describe below)
<p style="text-align: center;"><u>Log landing area:</u></p> <input checked="" type="checkbox"/> anti-tracking pad <input type="checkbox"/> curb cut	<p style="text-align: center;"><u>Roads</u></p> <p>Are new roads, other than skid trails, to be constructed for transport of logs or other activities associated with this harvest?</p> <input type="checkbox"/> Yes <input checked="" type="checkbox"/> No

Describe in further detail as necessary:

There are four intermittent drainage crossings associated with this operation that will be stabilized with corduroy and/or temporary bridge mats during the operation and removed upon completion. All best management practices regarding timber harvesting as adopted by the CT DEEP shall be strictly adhered to.

The following maps are attached to this "Notification" (Check all that apply)

- Copy of USGS topographic map with property outlined
- Copy of Assessor's map with property outlined
- Timber Harvest Area map showing outline of harvest area, main skid road locations, log landing area, truck access roads, inland wetlands, watercourses and any crossings

The undersigned hereby swear that the information contained in this application is true, accurate and complete to the best of my (our) knowledge and belief and that the timber harvest will be conducted in accordance with the specifications outlined in this "Notification of Timber Harvest."

Signature of Landowner(s): see item # 10 on the attached Timber Sale Agreement Date: _____

Print/Type Name: _____

Signature of Landowner(s): _____ Date: _____

Print/Type Name: _____

Signature of Certified Forest Practitioner:  Date: 6/22/19

Print Name: Chris Casadei

Certificate #: F-463 Expiration Date: 11 / 1 / 20

Complete and Submit to:

- The Municipal Inland Wetlands Agency/ies in which the property is located, and
- A courtesy copy of this Notification Form should also be sent to The Department of Environmental Protection, Division of Forestry 79 Elm Street, Hartford, CT, Tel: (860) 424-3630

This is not an official CT DEP form but it has been endorsed for town usage by: CT Farm Bureau Assoc., CT Forest & Park Assoc., CT Professional Timber Producers, Society of American Foresters - CT Chapter, and others.

TIMBER SALE AGREEMENT

It is agreed between James J. and Sheila C. Ilewicz of 81 Roth Road, Killingly, CT 06241 hereinafter called the Seller and Hull Forest Products, Inc. of 101 Hampton Road, Pomfret Center, CT 06259 hereinafter called the Purchaser, that the Purchaser shall buy from the Seller and the Seller shall sell to the Purchaser, certain designated standing trees or timber located on approximately 129 acres West of Roth Road in the Town of Killingly, in the State of CT. It is further agreed that the Purchaser may enter upon the land of the Seller for the purpose of cutting and removing such designated trees or timber, and is authorized to prosecute such work, on the area described above subject to the following conditions:

1. The price for the designated trees or timber to be cut shall be _____ or an estimated 154,070 board feet of sawtimber and 104 cords of firewood. Payment terms shall be as follows: \$ _____ shall be paid upon acceptance of this agreement, _____ within one week of the start of the operation, _____ when 1/3 of the operation is complete and _____ when 2/3 of the operation is complete.
2. All trees or standing timber cut under this agreement shall be removed from the land of the Seller within 12 months of the date of the agreement. In the event of wet weather or inappropriate ground conditions the Seller reserves the right to suspend harvesting operations and shall grant an extension of this agreement, if needed, for the same period of time suspended.
3. The Seller hereby covenants and agrees that they are lawfully possessed of the above described goods, chattels, and personal property as their own property.
4. Trees sold to the Purchaser shall be 788 sawtimber trees and 729 firewood trees as designated with a blue paint mark upon the base of the trunk. The prescription involves the salvage of trees killed by repeated gypsy moth defoliation and subsequent drought, an Ash presalvage harvest ahead of the eminent infestation of the Emerald Ash Borer as well as a conservative selection harvest of the residual stand. The Purchaser shall determine the use of the marked material and remove only material determined to be of commercial value as sawtimber or firewood.
5. The Purchaser agrees to indemnify and save harmless the Seller from all claims of personal injury, demands, suits and other legal proceedings arising or incidental to his operations. Hull Forest Products agrees to carry a minimum of \$1,000,000.00 General Liability Insurance and \$500,000.00 Workmen's Compensation Insurance for the duration of the harvest and to provide the Seller with certificates of insurance confirming said insurance coverage, and to name the Seller as an additional insured on such policies for the period of harvest.

6. Care shall be exercised in the felling, cutting and removal operations so that undesignated standing trees will not be unnecessarily damaged.
7. Excessive rutting (greater than 8" in depth) shall be repaired by the Purchaser.
8. Purchaser shall take precautions to prevent spillage of petroleum products or hazardous materials while refueling or performing maintenance on harvesting equipment. The Purchaser shall indemnify and hold the Seller harmless for any and all damages, including attorney fees and civil penalties, for which the Seller may become liable as a result of any such spillage.
9. All trees designated for removal by the Purchaser shall be cut as low as possible and in such a manner that the stump mark of paint is visible.
10. The Purchaser shall be responsible for following all rules and regulations regarding the harvest of forest products in the State of CT and the Town of Killingly and for obtaining all permits required for such harvest.
11. The Purchaser agrees to slash the tops from the timber harvested to a height not to exceed three feet above ground level on the property of the Seller.
12. In the case of a dispute over the terms of this agreement, a final decision shall rest with a reputable person, to be mutually agreed upon by the parties to this agreement. In the case of further disagreement, an arbitration board of three people will be selected, one by each party to the agreement and the third selected by those two, and the decision of the majority shall be final with respect either to acts to be done or compensation to be paid by either party to the other.
13. Any additional timber to be harvested shall be marked and measured by the Purchaser and agreed upon by both the Purchaser and Seller prior to its removal.

Dated this 19th day of June, 2020

Seller

By 
James J. Ilewicz

Hull Forest Products, Inc.

By 
Christopher J. Casadei, Forest Resources Manager
Duly Authorized

By 
Sheila C. Ilewicz

Sustainable Erosion Control Solutions
You can trust!


TIDEWALL



The best value in vinyl sheet piling



LONG LIFE
COST EFFECTIVE
RESISTANCE TO UV
RAPID INSTALLATION
ENVIRONMENTALLY FRIENDLY

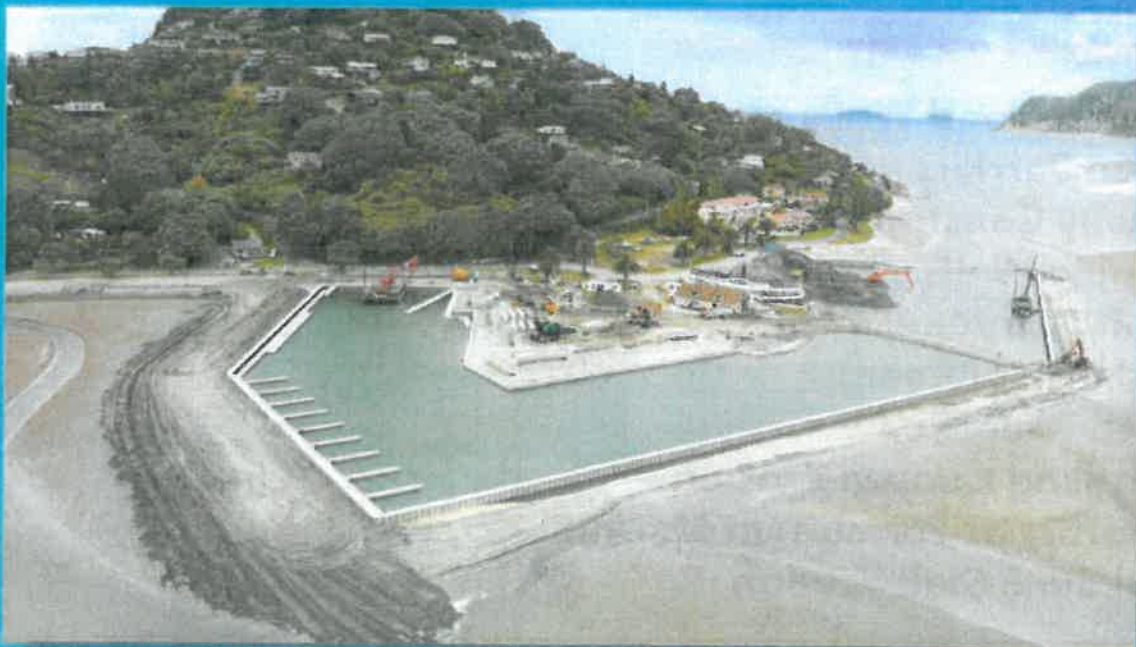



The best value in vinyl sheet piling



Tidewall vinyl sheet piling offers tremendous value to almost any sheet piling project. Much lower cost than steel or concrete alternatives, it is a strong, lightweight, UV and impact resistant, long-lasting product with major advantages. Tidewall does not rust, corrode, crack, or spall. Tidewall is inert, and friendly to the environment around it. Tidewall retains its structural integrity for decades, and is warrantied for 60 years.

For flood protection, erosion walls, seepage barriers, or retaining walls, Tidewall vinyl sheet piling can provide a permanent, high-value solution for your project.

APPLICATIONS


- Dike and Flood Walls**
- Erosion Barriers**
- Highway Construction**
- Retaining Walls**
- Cut-off (seepage) Walls**
- Canal Containment**
- Marina Protection**
- Controlling Coastal Erosion**
- Temporary or Permanent Shoring**
- Canal Bank Stabilization**



About Tidewall

The Tidewall dream team was formed by the merger of the original vinyl seawall manufacturer, Bama Plastics; and a premier vinyl recycling company, Regenex Corporation.

Bama Plastics brings more than 20 years of contract sheet piling manufacturing to our partnership; more than any other company. In fact, you may be surprised to discover that several sheet piling suppliers don't even do their own manufacturing. Much of the sheet piling installed under another name was in fact originally produced under contract by Bama Plastics.

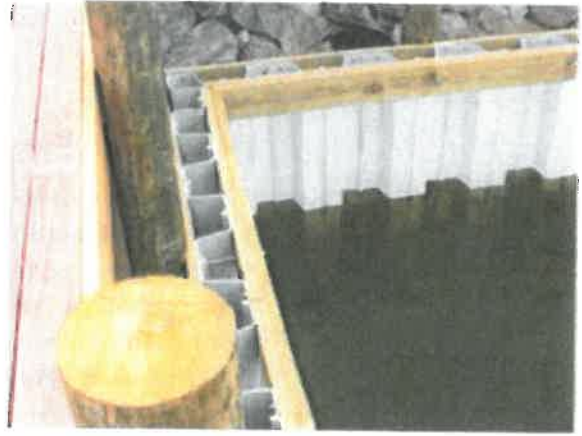

Regenex Corporation has been a leader in the vinyl recycling industry since 1992. Over the years, Regenex has supplied millions of pounds of premium recycled vinyl window compound to the vinyl sheet piling industry. Vinyl window compound is the best, most weatherable, impact modified compound for vinyl sheet piling. Other vinyl sheet piling suppliers may use lower grade siding, fencing, or pipe grade compounds.

The partnership of these two companies to form Tidewall offers tremendous benefits. We have the ability to completely control our quality, insuring a beautifully finished, premium quality wall. From the specification and sourcing of the raw material, to the careful processing and blending, to the state of the art extrusion, our quality is second to none.


This vertical integration also gives us unmatched cost control. Because of this, we have made it our goal to make Tidewall sheet piling more affordable to you. We welcome price comparisons between Tidewall and other sheet piling products.

Tidewall vinyl sheet piling has been installed in many countries around the world, for flood walls, erosion protection walls, cut-off walls, etc. The combination of performance and low cost leads to our motto "THE BEST VALUE IN VINYL SHEET PILING".

One final comment: Bama Plastics and Regenex Corporation both built their reputations upon outstanding customer service, and that tradition continues with Tidewall. We bend over backwards to meet our customer's needs, and when we make a commitment, we will live up to it. You can count on it!



APPLICATIONS

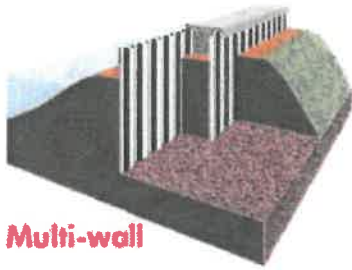

Multi-wall

Dikes and Flood Walls

Tidewall is an excellent option for flood protection walls. Either as a stand-alone wall, or to increase the height of an existing dike, or in a terraced multi-wall system, Tidewall is a cost-effective solution to protecting flood prone areas.



Stand-alone

Erosion Barriers

Tidewall has long been used to control erosion at the interface between land and water. Property located on lakes, canals, ponds, and other waterways is subject to erosion that can recede the shoreline. Tidewall provides a permanent solution that eliminates erosion, and improves the use and functionality of the property.




Navy Style



Cantilevered

Road Construction

Tidewall can be used in several ways in road construction. First, for roads that are built across a slope, Tidewall has been used as a retaining wall to allow construction of a shoulder, and to diminish the gravitational stress on the roadbed. Second, it can be used as a cut-off or seepage wall to keep subterranean water away from bridge abutments and road supports.

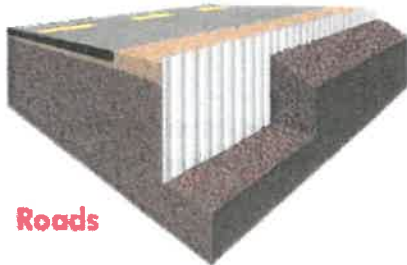

Roads

Retaining Walls


Tidewall can be used as a retaining wall, either as a single wall or as a series to terrace a sloped surface, allowing more effective utilization of the land. Especially in applications where aesthetics are important, Tidewall retaining walls provide a superior alternative to steel or wood.



Retaining

Cut-off (seepage) Walls


Tidewall can be used quite effectively to control the flow and seepage of subterranean fluid. Many applications, from the protection of structures, to the containment of landfill effluent, to wetlands management, can effectively utilize Tidewall vinyl sheet piling to create a barrier to underground fluid migration.

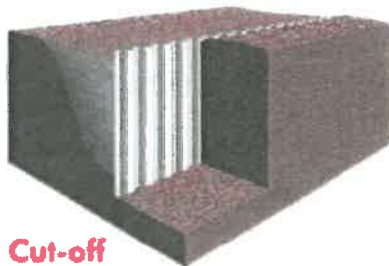

Cut-off

Canal Containment

Managing and controlling water resources via canal structures is becoming more important in many areas. Tidewall offers an effective low-cost alternative for canal containment.

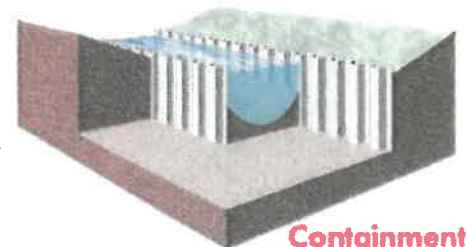

Containment

BENEFITS



		Steel	Concrete	Wood
Cost	Low	High	Medium	Low
Weight	Light	Heavy	Extra Heavy	Medium
Resistance to Corrosion	High	Low	N/A	N/A
Resistance to Chemical & Sea Water Environment	High	Low	High	Low
Resistance to Cracking & Spalling	High	N/A	Medium	N/A
Warranty	60 Years	Varies	Varies	No
Environmentally Friendly	Yes	Yes	No	No
Locks	Yes	Yes	No	No
Aesthetics	High	Low	Medium	Medium
Installation	Easy	Easy	Difficult	Moderate
Design Flexibility	High	High	Moderate	High

COST - Tidewall vinyl sheet piling costs much less than the alternatives.

WEIGHT - Tidewall is much lighter and easier to ship and handle than any alternative.

RESISTANCE TO CORROSION - Unlike steel, Tidewall will not rust or corrode.

RESISTANCE TO CHEMICAL & SEA WATER ENVIRONMENT - Tidewall can be used in high salinity and many other corrosive environments.

RESISTANCE TO CRACKING & SPALLING - Unlike concrete, Tidewall will not crack or spall over time.

WARRANTY - Tidewall offers a 60 year transferrable warranty.

ENVIRONMENTALLY FRIENDLY - Tidewall is produced from 100% recycled rigid PVC compound. Further recycling of the material is also possible.

LOCKS - Tidewall locks are designed to allow the sheets to slide together smoothly, but remain locked together under load. It is possible to seal the locks to completely prevent moisture penetration.

AESTHETICS - Tidewall will maintain its appearance for many decades, unlike alternative materials.

INSTALLATION - Tidewall installs easily, using equipment and techniques commonly available.

DESIGN FLEXIBILITY - Graceful curves are possible, as well as clean, sharp corners, depending upon the project requirements.





Tidewall is manufactured from exterior grade highly weatherable,
UV stabilized rigid PVC.









Data Sheet

	UNIT	ASTM	TW25	TW30	TW35	TW50	TW70	TW75	TW80	TW85	TW95
Section Width (W)	mm	-	457	508	305	508	457	457	457	457	457
Section Depth (D)	mm	-	152	178	178	203	228	254	254	254	305
Flange Thickness (T)	mm	-	6.35	6.35	6.60	7.62	8.39	8.89	10.41	11.18	11.70
Weight	kg/m	-	7.10	8.05	5.07	9.41	8.91	10.28	11.58	12.06	13.25
Length (stock)	m	-	11.95	11.95	11.95	11.95	11.95	11.95	11.95	11.95	11.95
Moment of Inertia	cm ⁴ /m	-	3,742	5,653	5,708	9,655	12,008	17,698	19,241	22,709	32,179
Section Modulus	cm ³ /m	-	489	623	651	866	1,050	1,339	1,462	1,717	1,990
Ultimate Moment	kg-m/m	-	2,263	2,890	3,010	4,005	4,860	6,194	6,767	7,948	9,224
Allowable Moment	kg-m/m	-	1,132	2,890	1,505	2,002	2,430	3,097	3,383	3,980	4,612
Tensile Strength	Mpa	D638	44.8	44.8	44.8	44.8	44.8	44.8	44.8	44.8	44.8
Flexural Strength	Mpa	D790	78.0	78.0	78.0	78.0	78.0	78.0	78.0	78.0	78.0
Modulus of Elasticity (MD)	Mpa	D790	2,620	2,620	2,620	2,620	2,620	2,620	2,620	2,620	2,620
Notched Izod Impact Test	kg/cm	D256	2.46	2.46	2.46	2.46	2.46	2.46	2.46	2.46	2.46
Heat Deflection Temp.	°C	D648	70	70	70	70	70	70	70	70	70




Tidewall Vinyl Sheet Piling is engineered for the sheet piling construction industry according to
"United States Army Corp of Engineers design guidelines and tested to ASTM material specifications".

PROFILES

Z Profiles

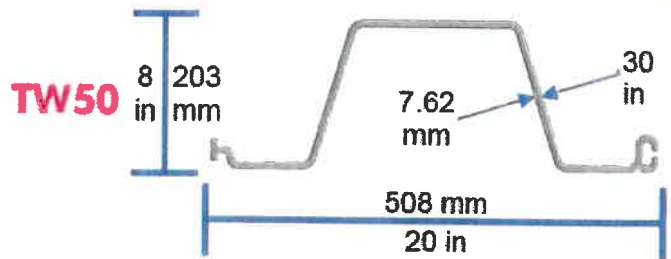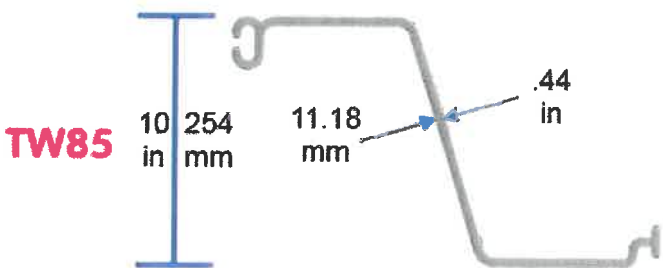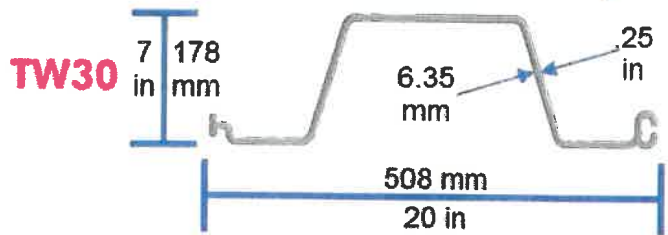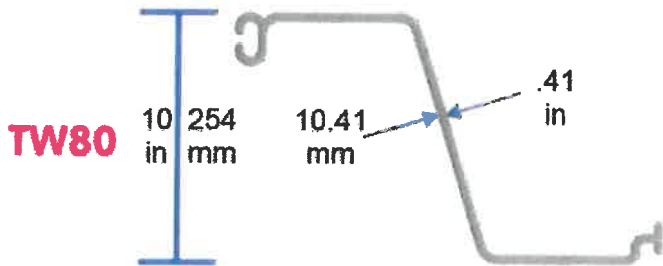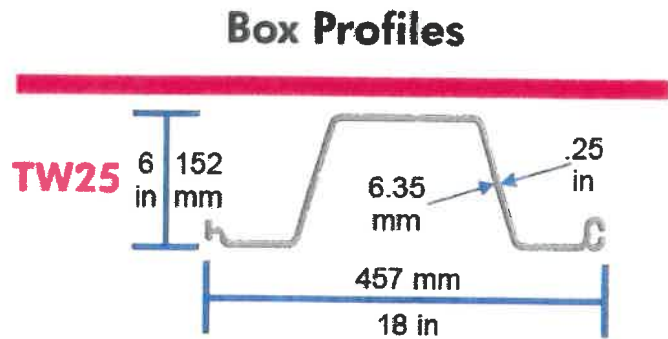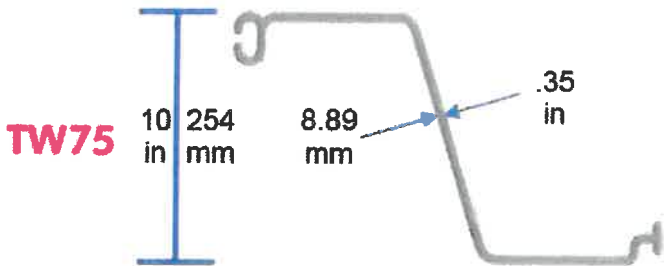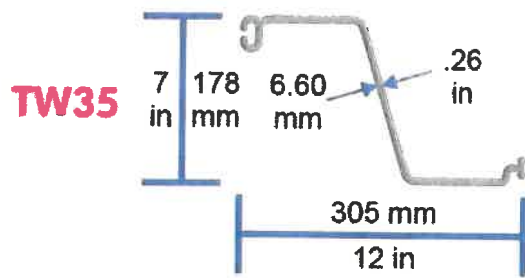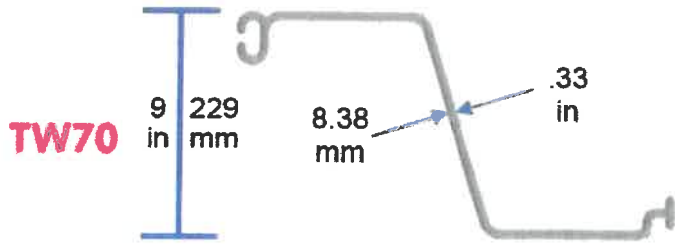

Corner Profiles

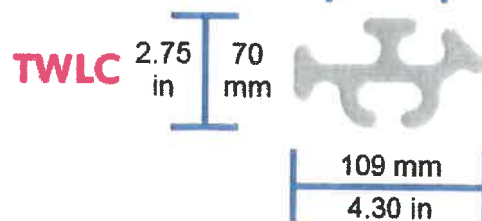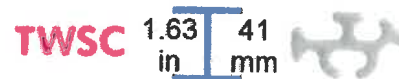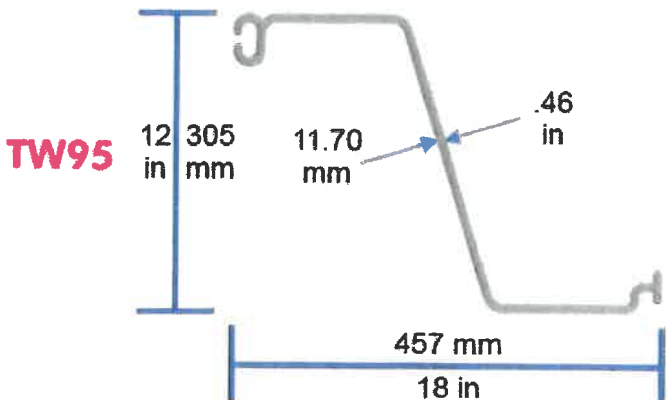

Engineering & Use of Tidewall

The use of Tidewall in any application should be done in compliance with engineering plans, drawings, and documentation. These should be developed and submitted for the particular project by a structural engineer or designer familiar with the materials and local site conditions. The application and installation of Tidewall should follow precisely these design specifications.

Installation

Tidewall is designed to be driven into the ground similar to steel sheet piles. Many different methods and equipment are used for driving Tidewall, but these are the most common driving methods.

VIBRO HAMMER

A vibro hammer is used to lift the sheets, sometimes in tandem, and vibrate the sheets into the soil. Much lighter weight vibro hammers should be used for Tidewall than would be used for steel piling, however.



PLATE COMPACTOR

In areas where the soil is moderately stiff or less, a plate compactor on a backhoe can drive Tidewall sheets smoothly and efficiently.

COMPRESSION DRIVING

Where the soils are very soft, simple compression driving works well to install Tidewall sheets. The bucket of a backhoe is used to exert downward pressure on the sheets, pressing them smoothly into the ground. This method works better with the heavier Tidewall Sheets such as TW75 and above.



Vietnam Flood Walls - Ho Chi Minh City, Vietnam



Installation: TW25, TW40, TW80
Linear Feet/Meters: 5,300 Linear Meters
Sheet Lengths: Varied
Soil Conditions: Sand/Silt, some clay
Existing Wall: None
Contractor: CNS Corporation
Design Engineer: CNS Corporation
Installation Method: Tracked Crane with Vibro Hammer



Tidewall was installed as a flood wall on several canals prone to flooding. The earthen dikes would erode and fail, allowing the flood waters to breach the dike. The Tidewall sheets were driven into the center of the dikes, with the wall projecting above the top of the dike to a specified height, providing a permanent solution to the flooding problems.

Tairua Marina - Tauranga, New Zealand



Installation: TW80 Clay
Linear Feet/Meters: 510 Linear Meters
Sheet Lengths: 5.4 and 6.4 Meters
Soil Conditions: Sand
Existing Wall: None
Contractor:
Design Engineer:
Installation Method: Plate Compactor



Tidewall sheets were used to construct a secure, permanent wall around a new high-end marina in Tauranga, New Zealand. Tidewall was chosen for its combination of aesthetics, corrosion resistance, and low cost. Precast concrete sections were placed atop the wall, and the final result is a beautiful wall that will last for decades.

Road Erosion - LaFourche Parish, LA



Installation: TW75
Linear Feet/Meters: 960 Linear Meters
Sheet Lengths: 3 Meters
Soil Conditions: 6' Organic soil above clay
Existing Wall: None
Contractor: Barriere Construction
Design Engineer: Duplantis Design Group
Installation Method: 315 Cat Excavator with flat press plate



Due to the extreme slope of the land, this road in Lafourche Parish in Louisiana was cracking and sliding down the slope, causing unsafe conditions and resulting in ongoing repair expenses. The problem was corrected using Tidewall TW75 in 3 meter long sheets, with approximately 2/3 meter of exposed height. This brought the shoulder of the road closer to the elevation of the road itself, relieving the stress on the asphalt and allowing permanent repairs to be made.

Thailand Floodwall - Bangkok, Thailand



Installation: TW80
Linear Feet/Meters: 250 Linear Meters
Sheet Lengths: 6 Meters
Soil Conditions: Sand and Clay
Existing Wall: Masonry Concrete behind
Contractor: CLS
Design Engineer: CLS
Installation Method: Portable Pile Hammer



Tidewall was installed as a flood wall surrounding a valuable commercial installation. Thailand experienced a major flood in 2011, resulting in a need for cost-effective floodwalls throughout populated areas. Tidewall was an ideal solution; a 2 meter high wall finished with a steel reinforced concrete cap.

Sustainable Erosion Control Solutions



The best value in vinyl sheet piling

TIDEWALL - USA

Tidewall
One New Street
P.O. Box 608
West Middlesex, PA. 16159, USA

Phone: 724-528-5900
Fax: 724-528-5903
email: info@tidewall.com
sales@tidewall.com
Website: www.tidewall.com



Your Regional Distributor

www.tidewall.com



58 Island Road - 6/19/2020 - Tide Wall





135 So Shore - 6/19/2020 - Existing Wall





Jonathan Blake

From: Dennis Lawlor <dplawlor1@hotmail.com>
Sent: Friday, June 19, 2020 2:43 PM
To: Jonathan Blake
Subject: 1460 North Road - Large Rock Boulder in Wetlands Meadow

Hi Jonathan.

It was a pleasure meeting you.

As you requested please find below the rational for my request for approval by the commission to remove the large rock / boulder that is in the wetlands meadow om my property;

- The existing rock / boulder poses no benefit to the existing wetlands meadow.
- The rock / boulder is a potential hazard for residential enjoyment ie: kids / grandkids could trip / fall and injure their head.
- Courts have said that the wetlands meadow can be maintained for and enjoyed by residential use.
- Area surrounding the rock / boulder is also wetlands meadow so no foreign material / soil could be brought into area where the rock is located.

If permission is granted, during removal careful considerations will be made to the wetlands meadow;

- No heavy excavating equipment will be used.
- Pick and shovel or residential lawn tractor or small farm backhoe will be used. Wood planking used under stabilizers.

Once the boulder is removed, the hole will be filled with organic soil. No grass seed will be applied and only natural surrounding vegetation will be allowed to grow on its own.

Attached are photos.

I look forward to hearing from you.



Regards,
Dennis Lawlor
1460 North road



Dayville, CT 06241-1428

Sent from [Mail](#) for Windows 10

Provost & Rovero, Inc.

Civil Engineering • Surveying • Site Planning • Structural • Mechanical • Architectural Engineering

P.O. Box 191
57 East Main Street
Plainfield, CT 06374

Telephone (860) 230-0856
Fax (860) 230-0860
www.prorovinc.com

April 30, 2020

Jonathan Blake
Town of Killingly
172 Main Street
Killingly, CT 06239

**RE: Snake Meadow Club – Snake Meadow Road – Killingly, CT
P&R Job No. 203011**

Dear Mr. Blake:

On behalf of Snake Meadow Club, Inc., we are requesting that the IWWC permit granted under application #15-1413 be extended for an additional five years from the current expiration date. The requested permit extension will coincide with the currently pending special permit application before the Planning & Zoning Commission. For your reference, I have attached the plans submitted as part of the special permit application. The proposed regulated activities are essentially the same what was originally approved. The regulated activities have been slightly reduced along the Snake Meadow Brook corridor on the westerly side of the project.

If you have any questions or need additional information, please do not hesitate to contact us at your convenience.

Sincerely,



David J. Held, P.E., L.S.
Provost & Rovero, Inc.

CC: Kevin Brignole, Snake Meadow Club, Inc.